





# SAINTSBURY LINE AND ALICE STREET RECONSTRUCTION TOWNSHIP OF LUCAN-BIDDULPH

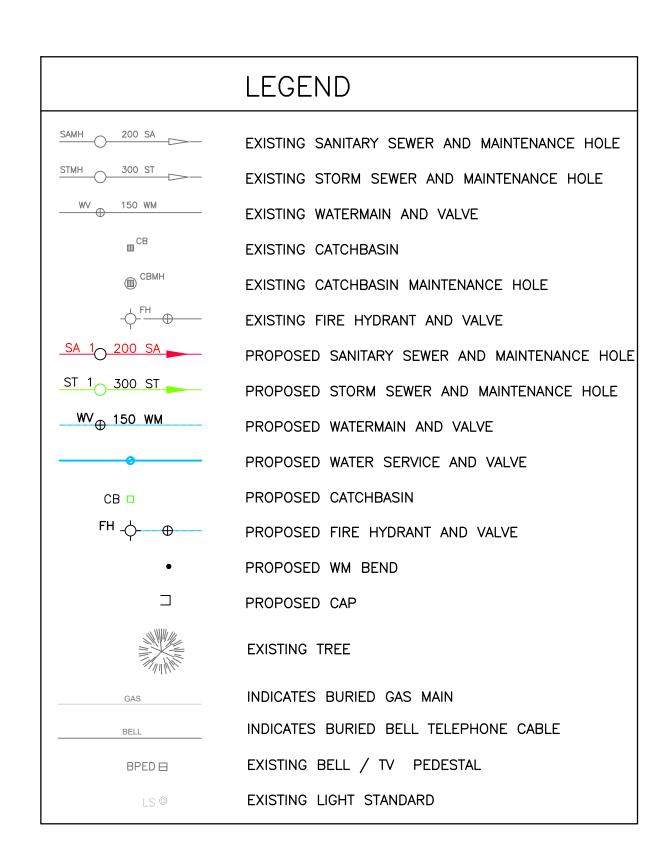

ALL EXISTING INVERTS TO BE FIELD CHECKED BY THE CONTRACTOR PRIOR TO CONSTRUCTION

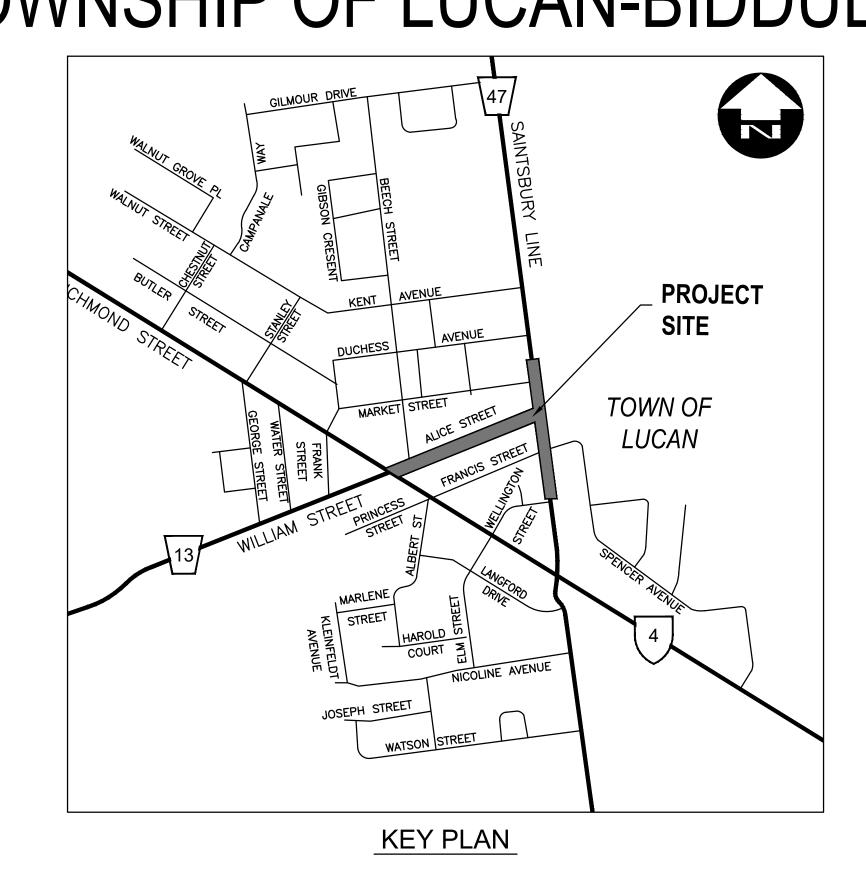

DILLON PROJECT: 21-2406/1788 DATE: MAY 2022

BENCHMARKS								
ID	NORTHING (m)	EASTING (m)	ELEVATION (m)	DESCRIPTION				
BM-A	4783423.3156	394450.7882	304.45	SOUTHWEST BOLT IN SIGN FOOTING AT MACEWEN GAS STATION				
ВМ-В	4783513.8763	394299.0335	304.50	SOUTHEAST CORNER OF PORCH AT 114 MAIN STREET				

DRAWING INDEX						
DRAWING No.	DESCRIPTION					
G	SENERAL NOTES AND DETAILS					
G1	SAINTSBURY LINE AND ALICE STREET					
	REMOVALS					
R1	SAINTSBURY LINE STA. 10+000 TO STA. 10+380					
R2	SAINTSBURY LINE STA. 10+380 TO 10+440					
R3	ALICE STREET 10+000+10+230					
R4	ALICE STREET STA. 10+230 TO STA. 10+420.110					
	NEW CONSTRUCTION					
C1	SAINTSBURY LINE STA. 10+000 TO STA. 10+190					
C2	SAINTSBURY LINE STA. 10+190 TO STA. 10+380					
C3	SAINTSBURY LINE STA. 10+380 TO STA. 10+420					
C4	ALICE STREET STA. 10+000 TO STA. 10+160					
C5	ALICE STREET STA. 10+160 TO STA. 10+230					
C6	ALICE STREET STA. 10+230 TO STA. 10+420.427					
	TYPICAL SECTIONS					
TS1	SAINTSBURY LINE STA. 10+230					
TS2	SAINTSBURY LINE STA. 10+300					
TS3	ALICE STREET. STA. 10+085					
PAVEM	ENT MARKINGS AND SIGNAGE PLAN					
PM1	SAINTSBURY LINE 10+000 TO 10+330					
PM3	ALICE STREET STA. 10+000 TO STA. 10+230					
PM3	ALICE STREET STA. 10+000 TO STA. 10+230					
PM4	ALICE STREET STA. 10+230 TO STA. 10+420.427					
	STORM SEWER SYSTEM					
ST1	STORM SEWER DRAINAGE AREA PLAN					
ST2	STORM SEWER DESIGN SHEET					
	STREET LIGHTING					
E1	STREET LIGHTING LAYOUT					
E2	STREET LIGHTING LAYOUT					
E3	WIRING DIAGRAM AND DETIALS					
E4	LUMINAIRES SPEC SHEET					
	\.					



3. TOPOGRAPHIC SURVEY COMPLETED BY AGM, LEGAL BOUNDARIES SHOWN ARE FOR INFORMATION PURPOSES ONLY. CONTRACTOR TO VERIFY PRIOR TO CONSTRUCTION.

4. ALL DISTURBED AREA'S TO BE RESTORED TO MATCH EXISTING CONDITIONS OR BETTER WITH THE FOLLOWING MINIMUMS:

BOULEVARD AREA CONC S/W 150mm TOPSOIL AND SOD 100MM CONC. ON 150mm GRAN 'A' GRAVEL D/W CONC S/W THROUGH D/W 300mm GRAN. 'A' 150mm CONC. ON 150mm GRAN 'A' ASPHALT D/W CONC D/W

4. CONTRACTOR TO SUBMIT A TRAFFIC CONTROL PLAN TO THE COUNTY OF MIDDLESEX AND ENGINEER FOR REVIEW PRIOR TO COMMENCING ANY WORK.

5. ALL BEDDING MATERIAL SHALL BE COMPACTED TO A MINIMUM OF 95% OF THE MATERIAL'S STANDARD PROCTOR MAXIMUM DRY DENSITY (SPMDD).

150mm CONC. ON 250mm GRAN 'A'

6. BACKFILL SHALL BE AS PER DETAILS INCLUDED IN CONTRACT DRAWINGS.

50mm HL3 ON 250mm GRAN. 'A'

7. ALL EXISTING UNDERGROUND PLANT (HYDRO, TELEPHONE, GAS MAINS, WATERMAINS, SEWERS) WHICH WILL BE CROSSED UNDER DURING THE INSTALLATION OF THE SERVICES SHALL BE SUPPORTED BY A SUPPORT BEAM OR BY OTHER METHODS, AS MAY BE REQUIRED BY THE OWNERS OF THE PLANT BEING CROSSED UNDER.

8. PRIOR TO COMMENCEMENT OF ANY CONSTRUCTION, ALL SEWER OUTLET INFORMATION, BENCHMARKS, ELEVATIONS, AND DIMENSIONS MUST BE CHECKED AND VERIFIED. AND ANY DISCREPANCIES REPORTED TO THE ENGINEER.

9. THE CONTRACTOR SHALL NOTIFY MIDDLESEX COUNTY AND DILLON CONSULTING LIMITED AT LEAST 48 HOURS PRIOR TO COMMENCING CONSTRUCTION ON THE ROAD ALLOWANCE.

10. THE CONTRACTOR SHALL TAKE ALL NECESSARY PRECAUTIONS UNDER THE OCCUPATIONAL HEALTH AND SAFETY ACT WHILE WORKING IN THE VICINITY OF OVERHEAD POWER LINES.

11. ALL EXCAVATION WHOLLY OR PARTLY WITHIN PROPOSED OR EXISTING ROADWAYS, SHALL BE BACKFILLED AND COMPACTED IN ACCORDANCE WITH ONTARIO PROVINCIAL STANDARD SPECIFICATIONS.

12. EXISTING TREES ARE NOT TO BE REMOVED UNLESS APPROVED BY THE APPLICABLE AUTHORITY HAVING JURISDICTION.

# EROSION CONTROL MEASURES

1. THE CONTRACTOR SHALL PREPARE A SEDIMENT AND EROSION CONTROL PLAN AND SUBMIT TO THE TOWNSHIP AND ENGINEER FOR REVIEW AND APPROVAL PRIOR TO ANY WORK COMMENCING.

2. THE CONTRACTOR SHALL CONSTRUCT TEMPORARY MEASURES TO CONTROL SILT ENTERING THE STORM DRAINAGE SYSTEM.

3. PROTECT ALL EXPOSED SURFACES AND CONTROL RUN-OFF DURING CONSTRUCTION.

4. ALL EROSION CONTROL MEASURES TO BE IN PLACE BEFORE STARTING CONSTRUCTION AND REMAIN IN PLACE UNTIL RESTORATION IS FULLY DEVELOPED (IE. GRASS).

5. MAINTAIN EROSION CONTROL MEASURES DURING CONSTRUCTION.

6. ALL COLLECTED SEDIMENT TO BE DISPOSED OF AT AN APPROVED LOCATION.

7. MINIMIZE AREA DISTURBED DURING CONSTRUCTION. ALL DISTURBED AREAS NOT SUBJECT TO ACTIVE CONSTRUCTION SHALL BE TOPSOILED AND SODDED.

8. ALL DEWATERING TO BE DISPOSED OF IN AN APPROVED SEDIMENT BASIN. UNDER NO CIRCUMSTANCES WILL DEWATERING EFFLUENT BE DISCHARGED DIRECTLY TO A WATERCOURSE.

9. PROTECT ALL EXISTING CATCH BASINS, MANHOLES AND PIPES ENDS FROM SEDIMENT INTRUSION.

10. KEEP ALL DITCHES AND SUMPS CLEAN DURING CONSTRUCTION.

11. STRAW BALES TO BE USED IN LOCALIZED AREAS AS DIRECTED BY THE ENGINEER.

12. PROVIDE A GRANULAR MATT TO PREVENT SOIL TRACKING AT ALL ENTRANCES TO EXISTING ROADS.

13. SEDIMENT CONTROL MEASURES TO CONFORM TO "EROSION AND SEDIMENT CONTROL GUIDE FOR URBAN CONSTRUCTION". 2019.

14. ALL EROSION AND SEDIMENT CONTROL MEASURES TO BE INSPECTED ON ALL DAYS WHEN CONSTRUCTION IS ACTIVE AND AFTER ALL RAINFALL EVENTS GREATER THAN 10mm.

15. IN THE EVENT OF A FAILURE OF AN EROSION AND SEDIMENT CONTROL MEASURE, THE CONTRACTOR WILL CEASE ALL OTHER CONSTRUCTION RELATED ACTIVITY UNTIL THE MEASURE IS REPAIRED.

16. ANY DISCHARGE OF SEDIMENT LADEN WATER OUTSIDE OF THE WORK LIMITS WILL BE MMEDIATELY REPORTED TO THE ONTARIO SPILLS ACTION CENTRE 1-800-268-6060.

17. INSTALL FILTER CLOTH AT ALL CATCHBASINS TO PREVENT SEDIMENT FROM ENTERING THE STORM SEWER.

# WATERMAIN NOTES


1. ALL WATERMAINS SHALL BE PVC CL 150-C900-DR18 IF INSTALLED BY OPEN CUT AND IF INSTALLED BY TRENCHLESS THE CONTRACTOR SHALL CHOOSE AN EQUIVALENT PIPE MATERIAL TO ACCOMMODATE SUCH INSTALLATION (SUBMIT MATERIAL SPEC. FOR REVIEW AND APPROVAL PRIOR TO ORDERING MATERIAL).


2. RESTRAINED JOINTS: RESTRAINED PIPE JOINTS ARE REQUIRED AT ALL HORIZONTAL AND VERTICAL DEFLECTIONS. THE CONTRACTOR SHALL SUBMIT DESIGN CALCULATIONS AND RESTRAINT DETAILS TO ENGINEER AND TOWNSHIP PRIOR TO PIPE FABRICATION FOR APPROVAL.


3. A MINIMUM OF 0.5m VERTICAL CLEARANCE SHALL BE MAINTAINED BETWEEN ALL WATERMAIN AND SEWER CROSSINGS.


4. THE CONTRACTOR SHALL SUBMIT A SWABBING AND CHLORINATION PLAN FOR TESTING OF THE NEW WATERMAIN SYSTEM FOR APPROVAL.

5. ALL WATERMAINS AND SERVICES SHALL HAVE TYPE 1 BEDDING.

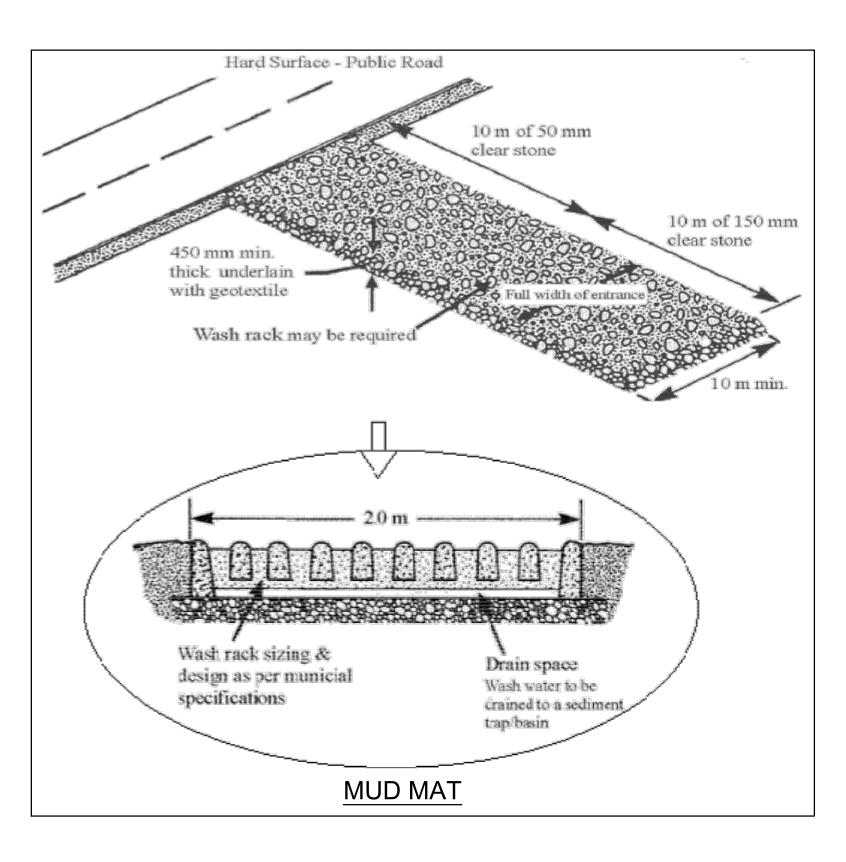

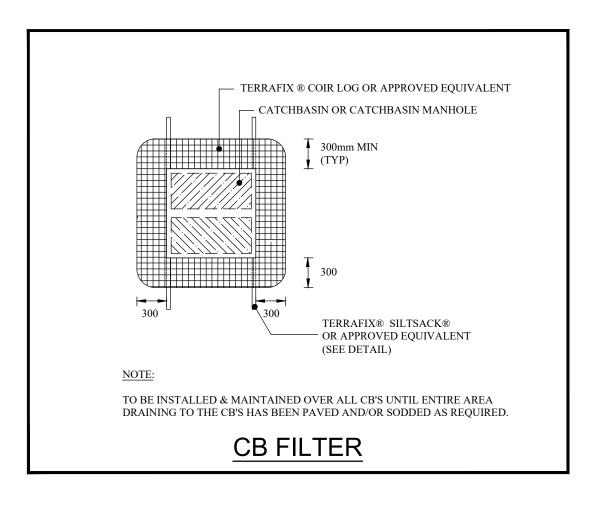

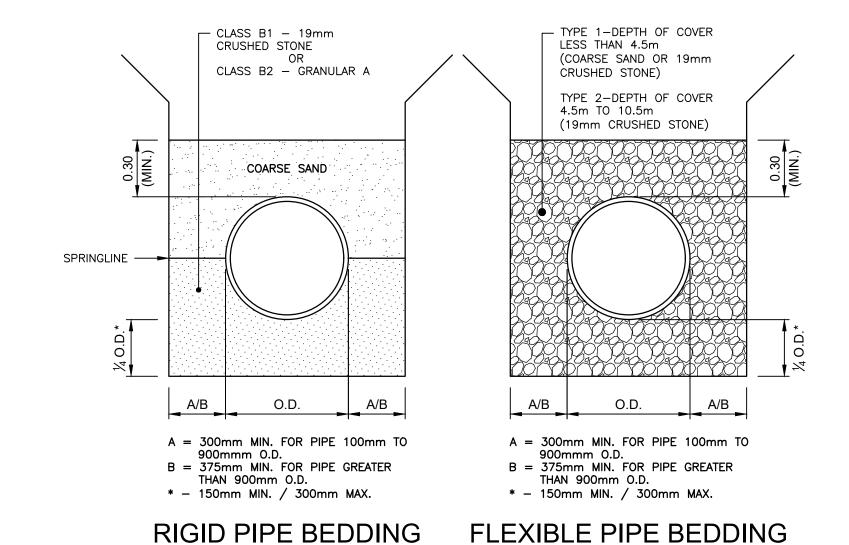

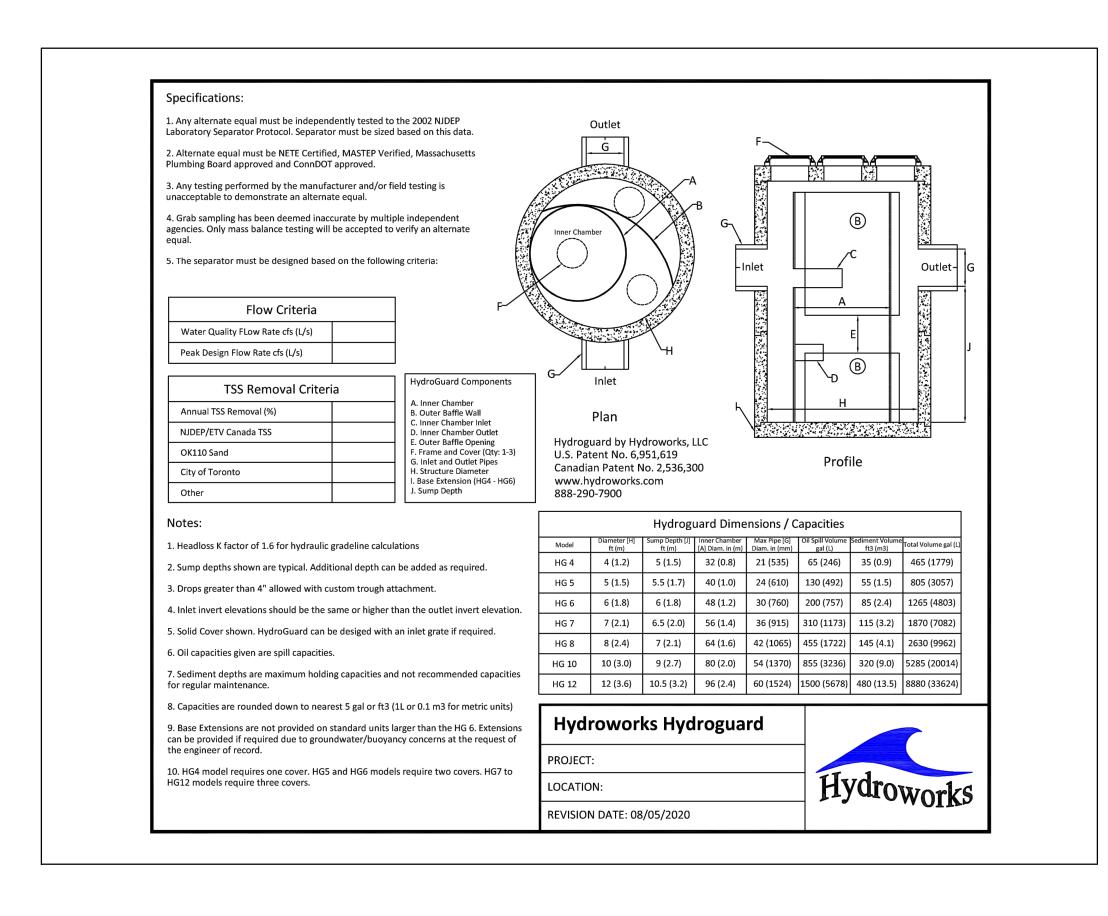


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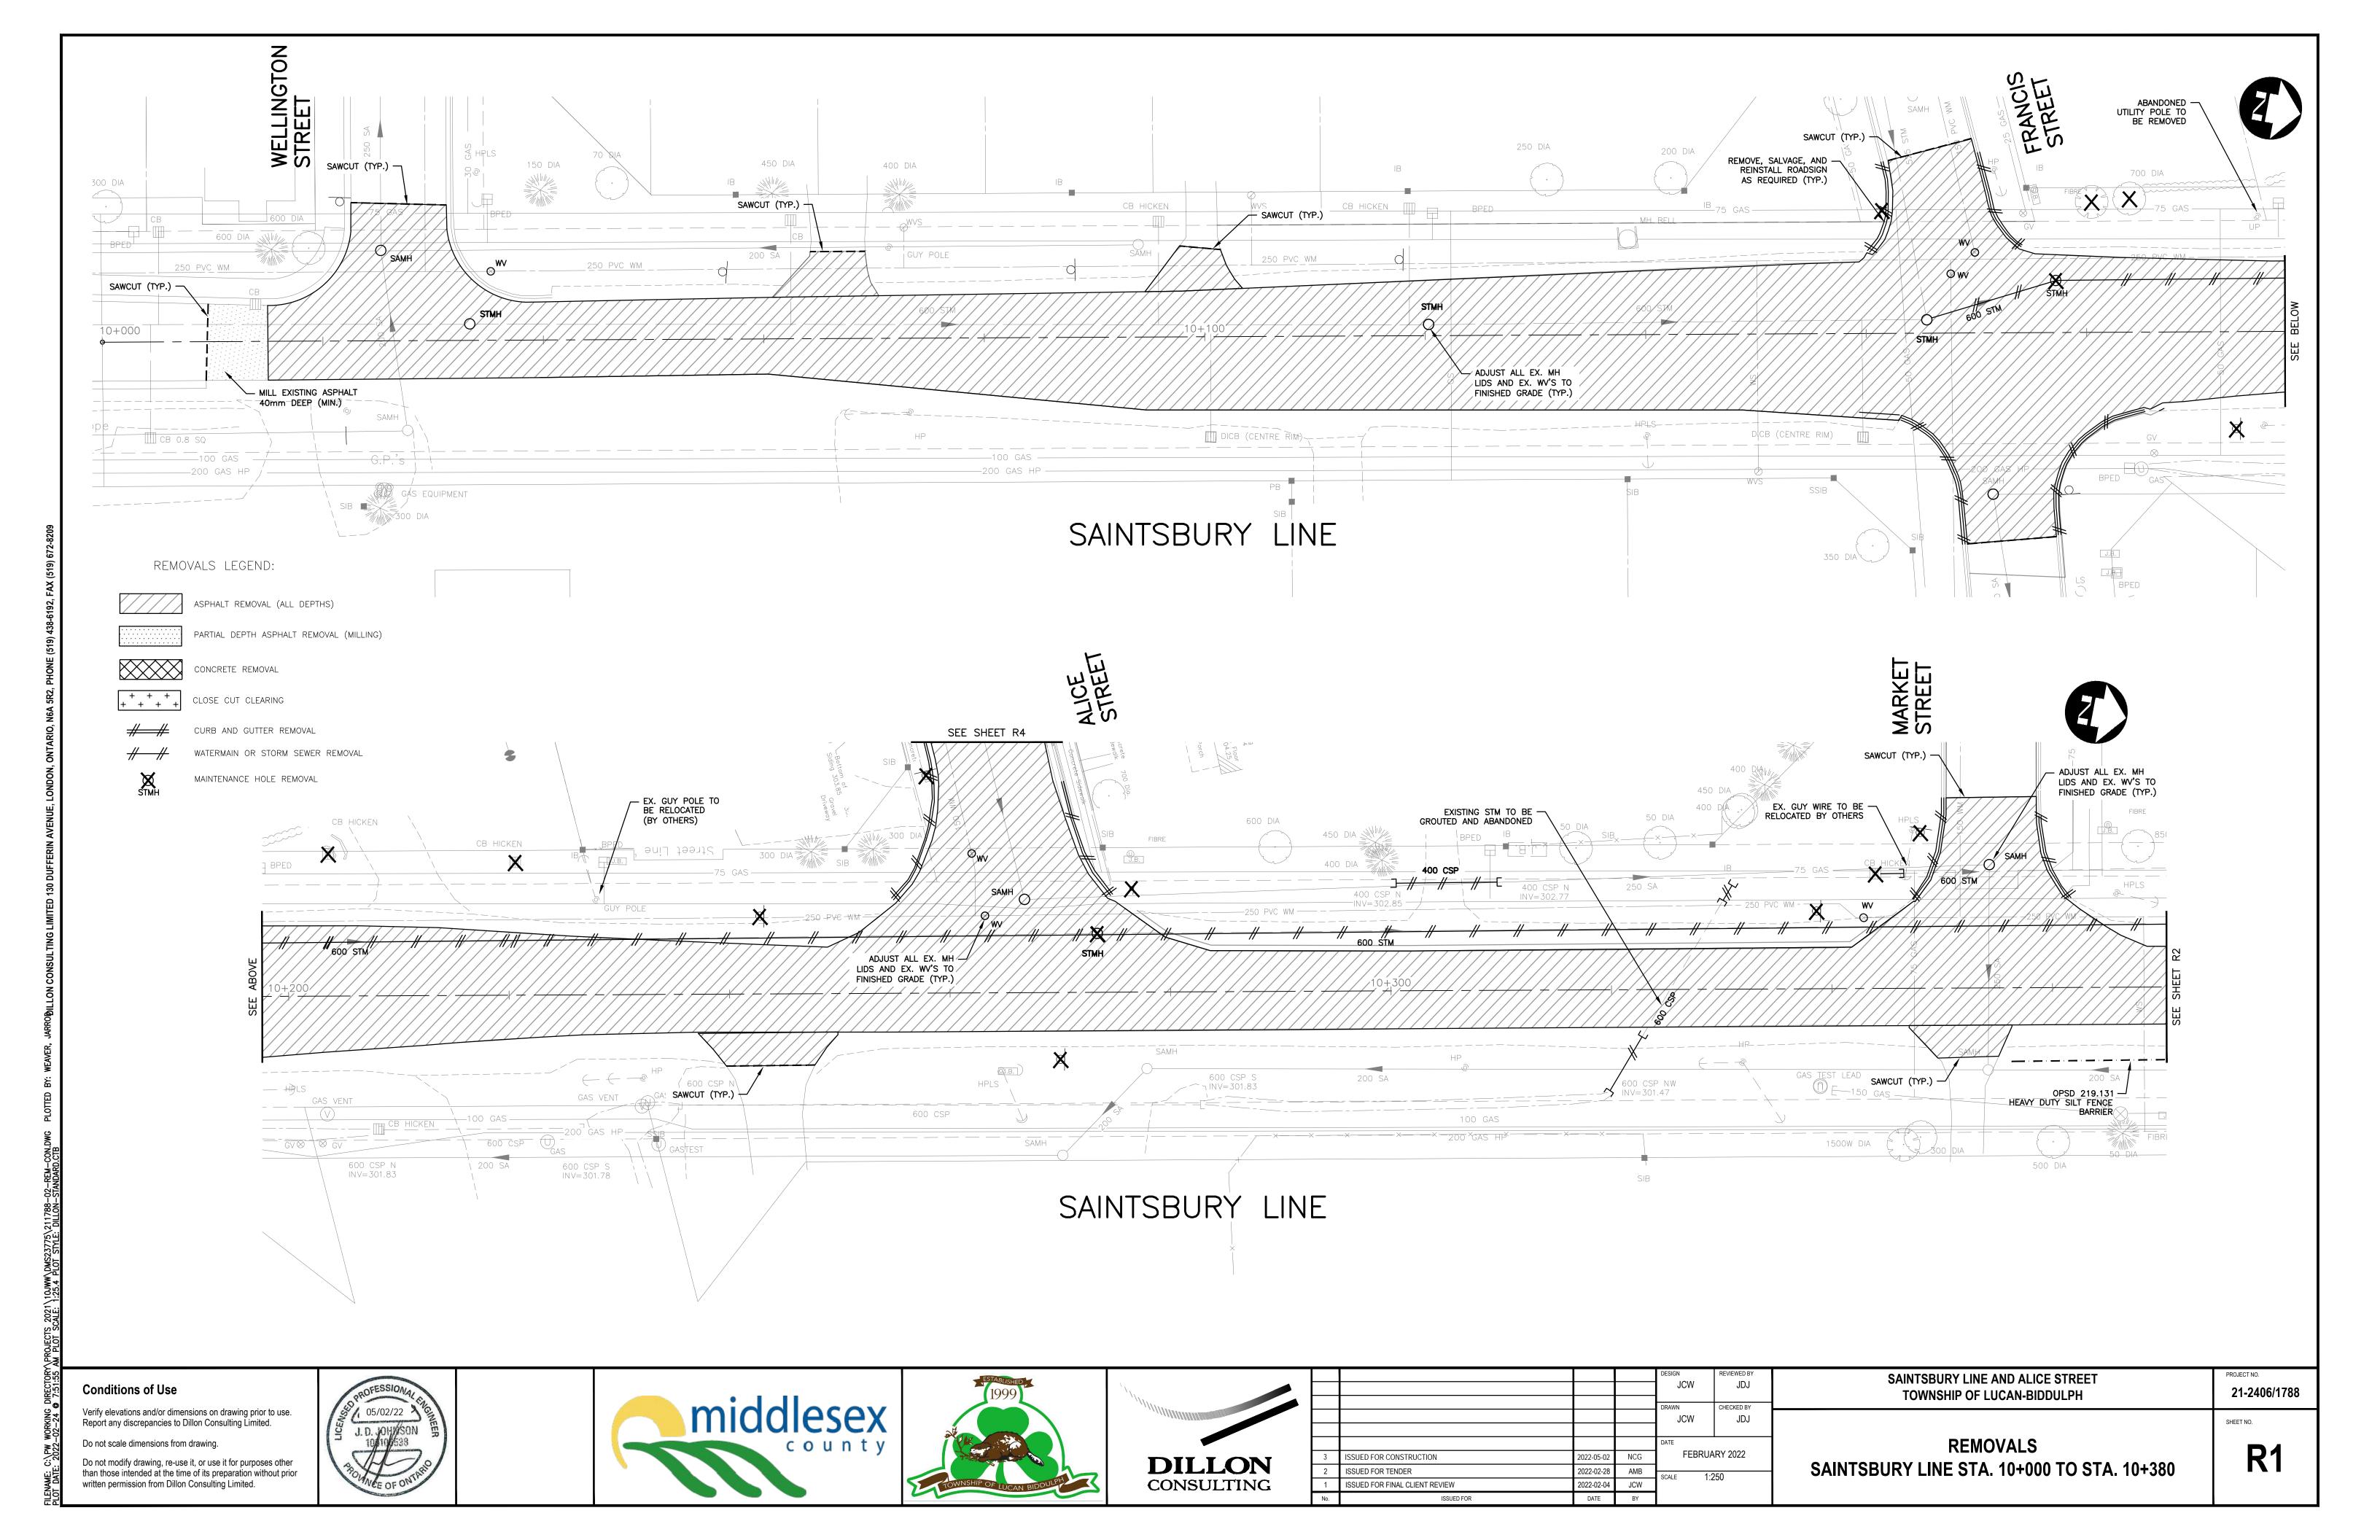
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2	ISSUED FOR TENDER	2022-02-28	AMB			
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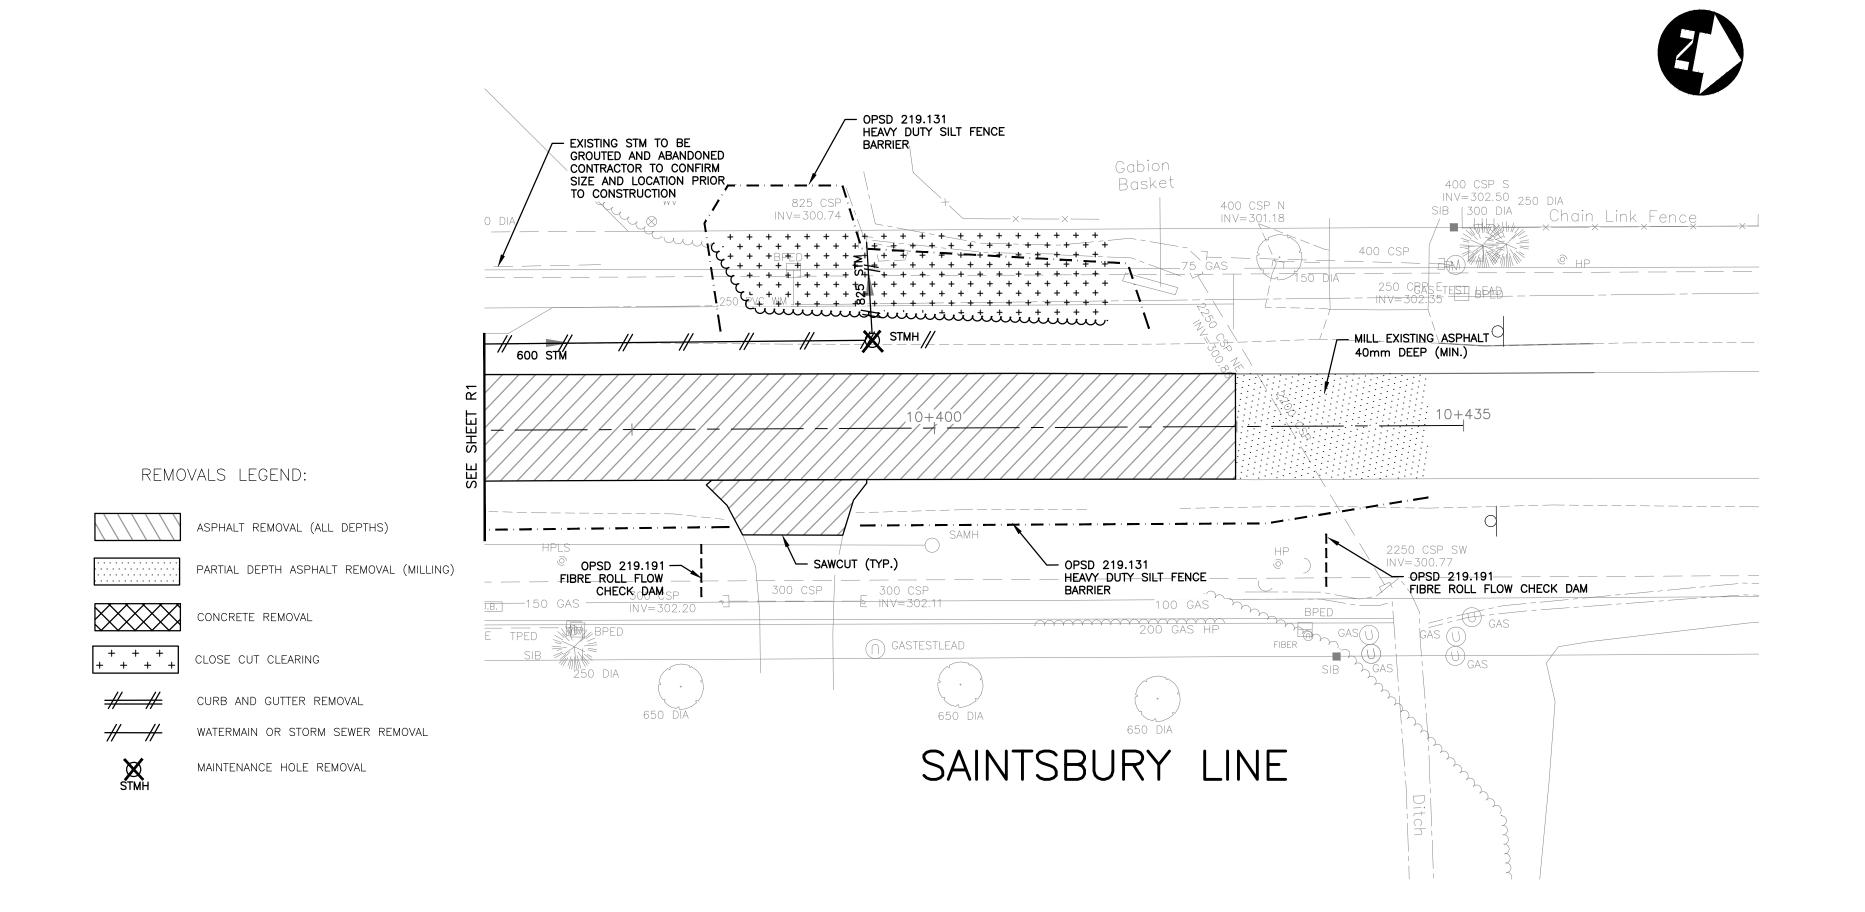
**GENERAL NOTES AND DETAILS** 

SAINTSBURY LINE AND ALICE STREET

TOWNSHIP OF LUCAN-BIDDULPH

SHEET NO.

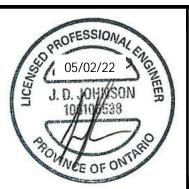



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	1	ISSUED FOR FINAL CLIENT REVIEW	2022-02-04	JCW	scale 1:250		
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REMOVALS SAINTSBURY LINE STA. 10+380 TO 10+440


SAINTSBURY LINE AND ALICE STREET

TOWNSHIP OF LUCAN-BIDDULPH

+440 R2

21-2406/1788

SHEET NO.

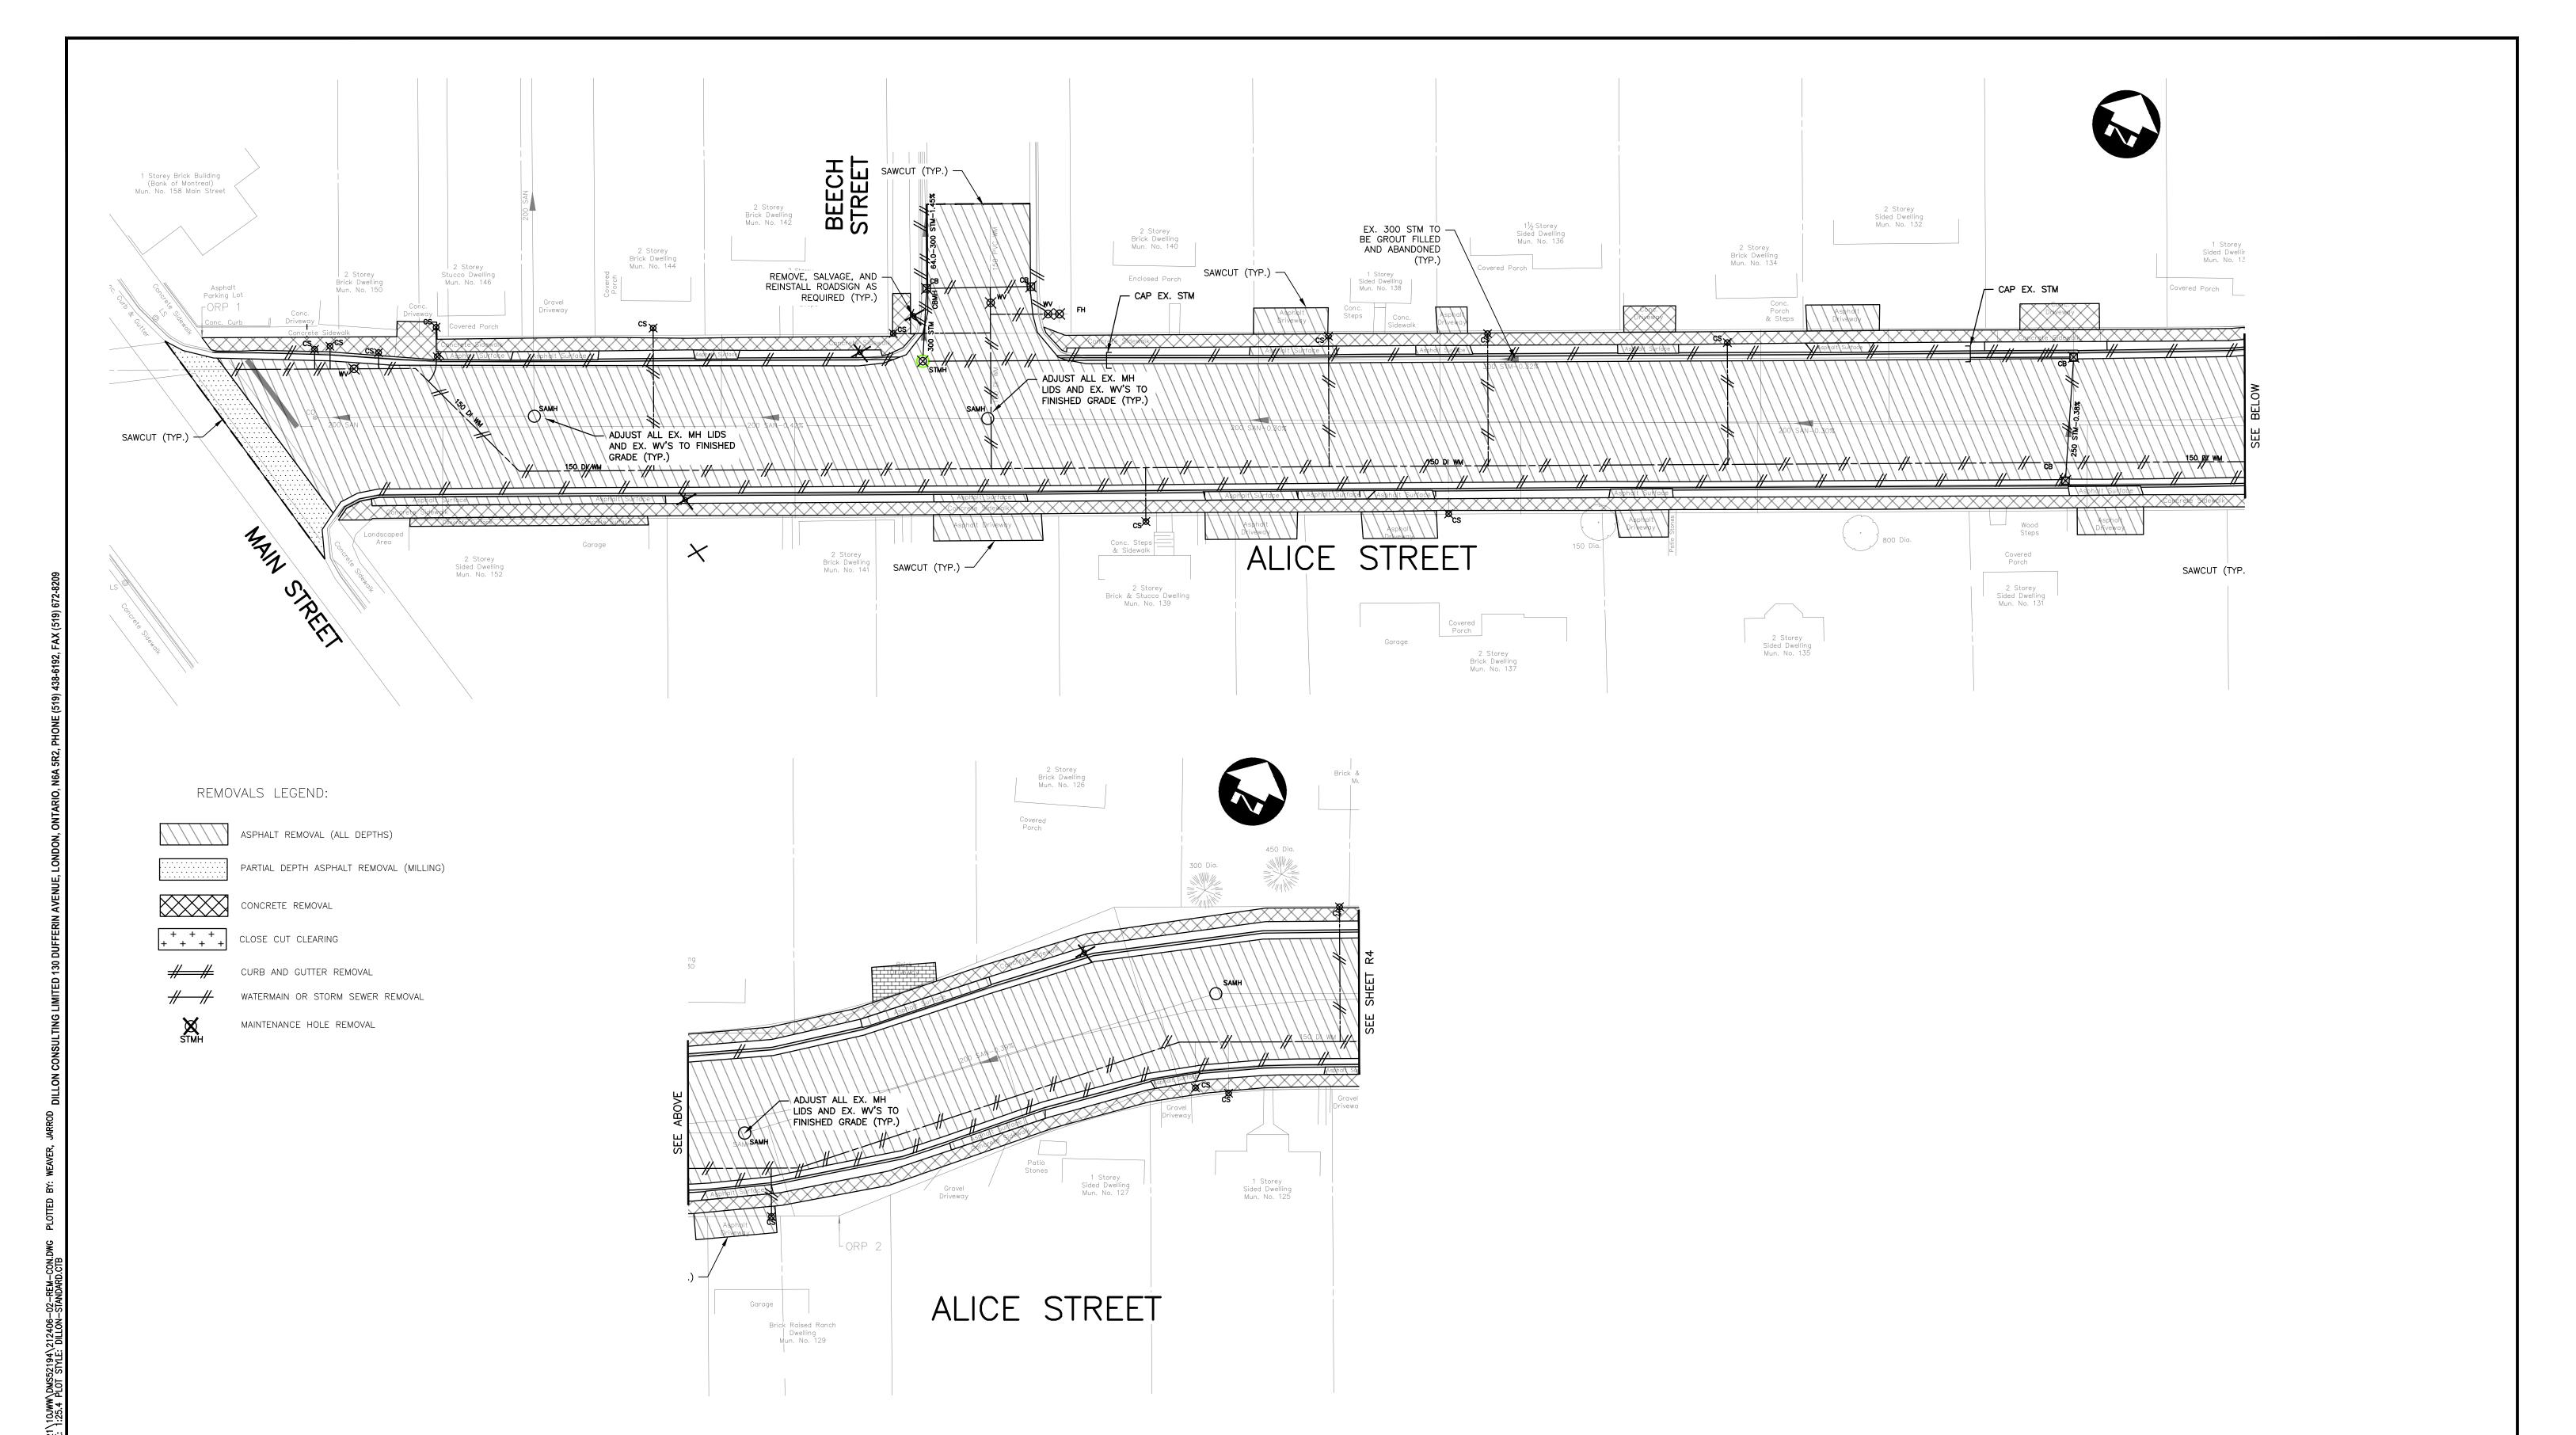

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<b>DILLON</b> CONSULTING

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TOWNSHIP OF LUCAN-BIDDULPH SHEET NO. **REMOVALS R3** ALICE STREET 10+000+10+230

21-2406/1788

SAINTSBURY LINE AND ALICE STREET



ASPHALT REMOVAL (ALL DEPTHS)

PARTIAL DEPTH ASPHALT REMOVAL (MILLING)


CONCRETE REMOVAL

+ + + + + CLOSE CUT CLEARING

CURB AND GUTTER REMOVAL

WATERMAIN OR STORM SEWER REMOVAL

MAINTENANCE HOLE REMOVAL

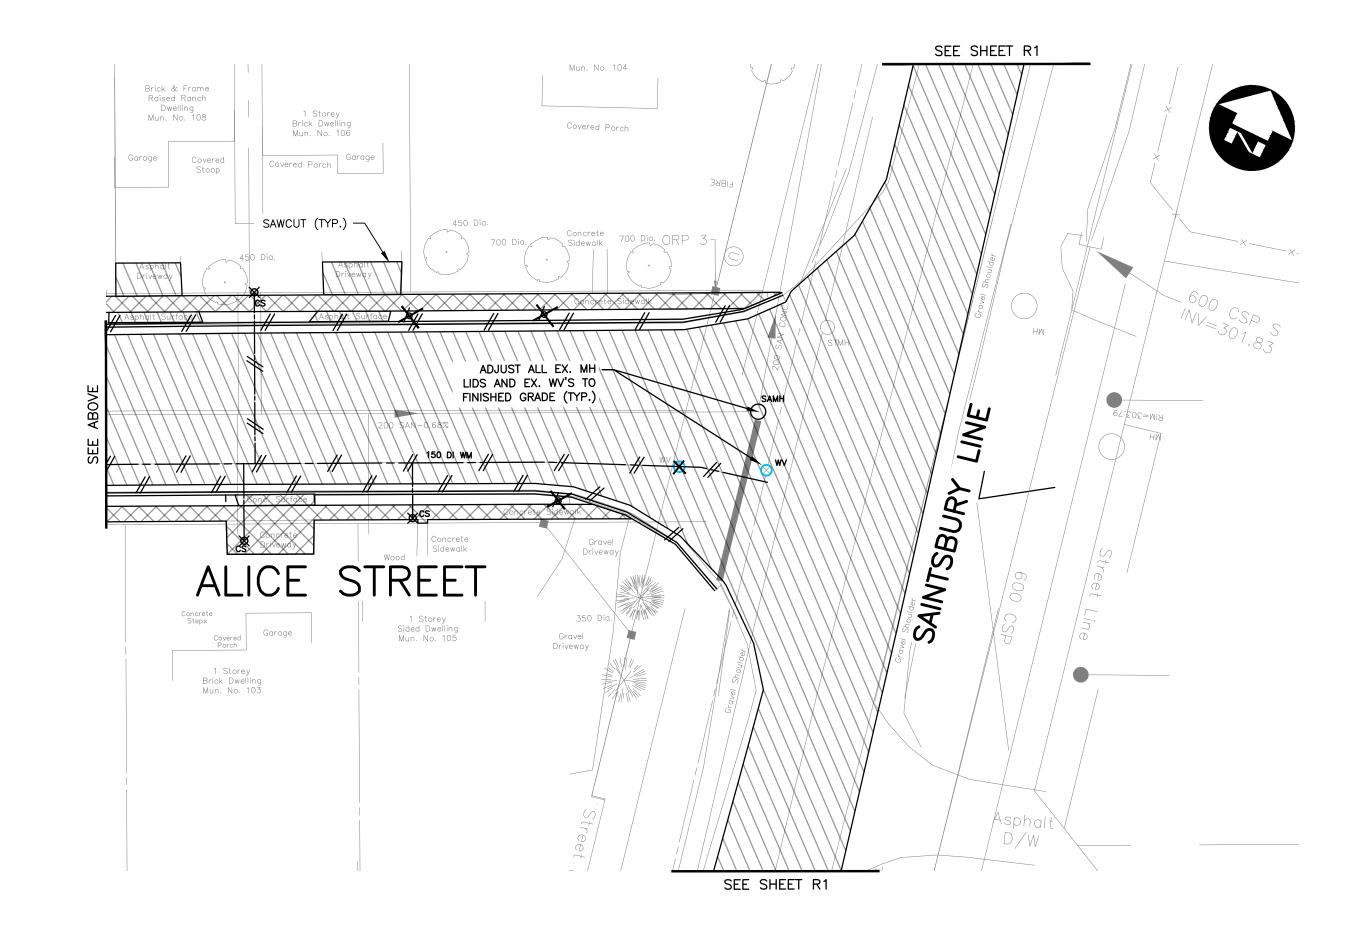


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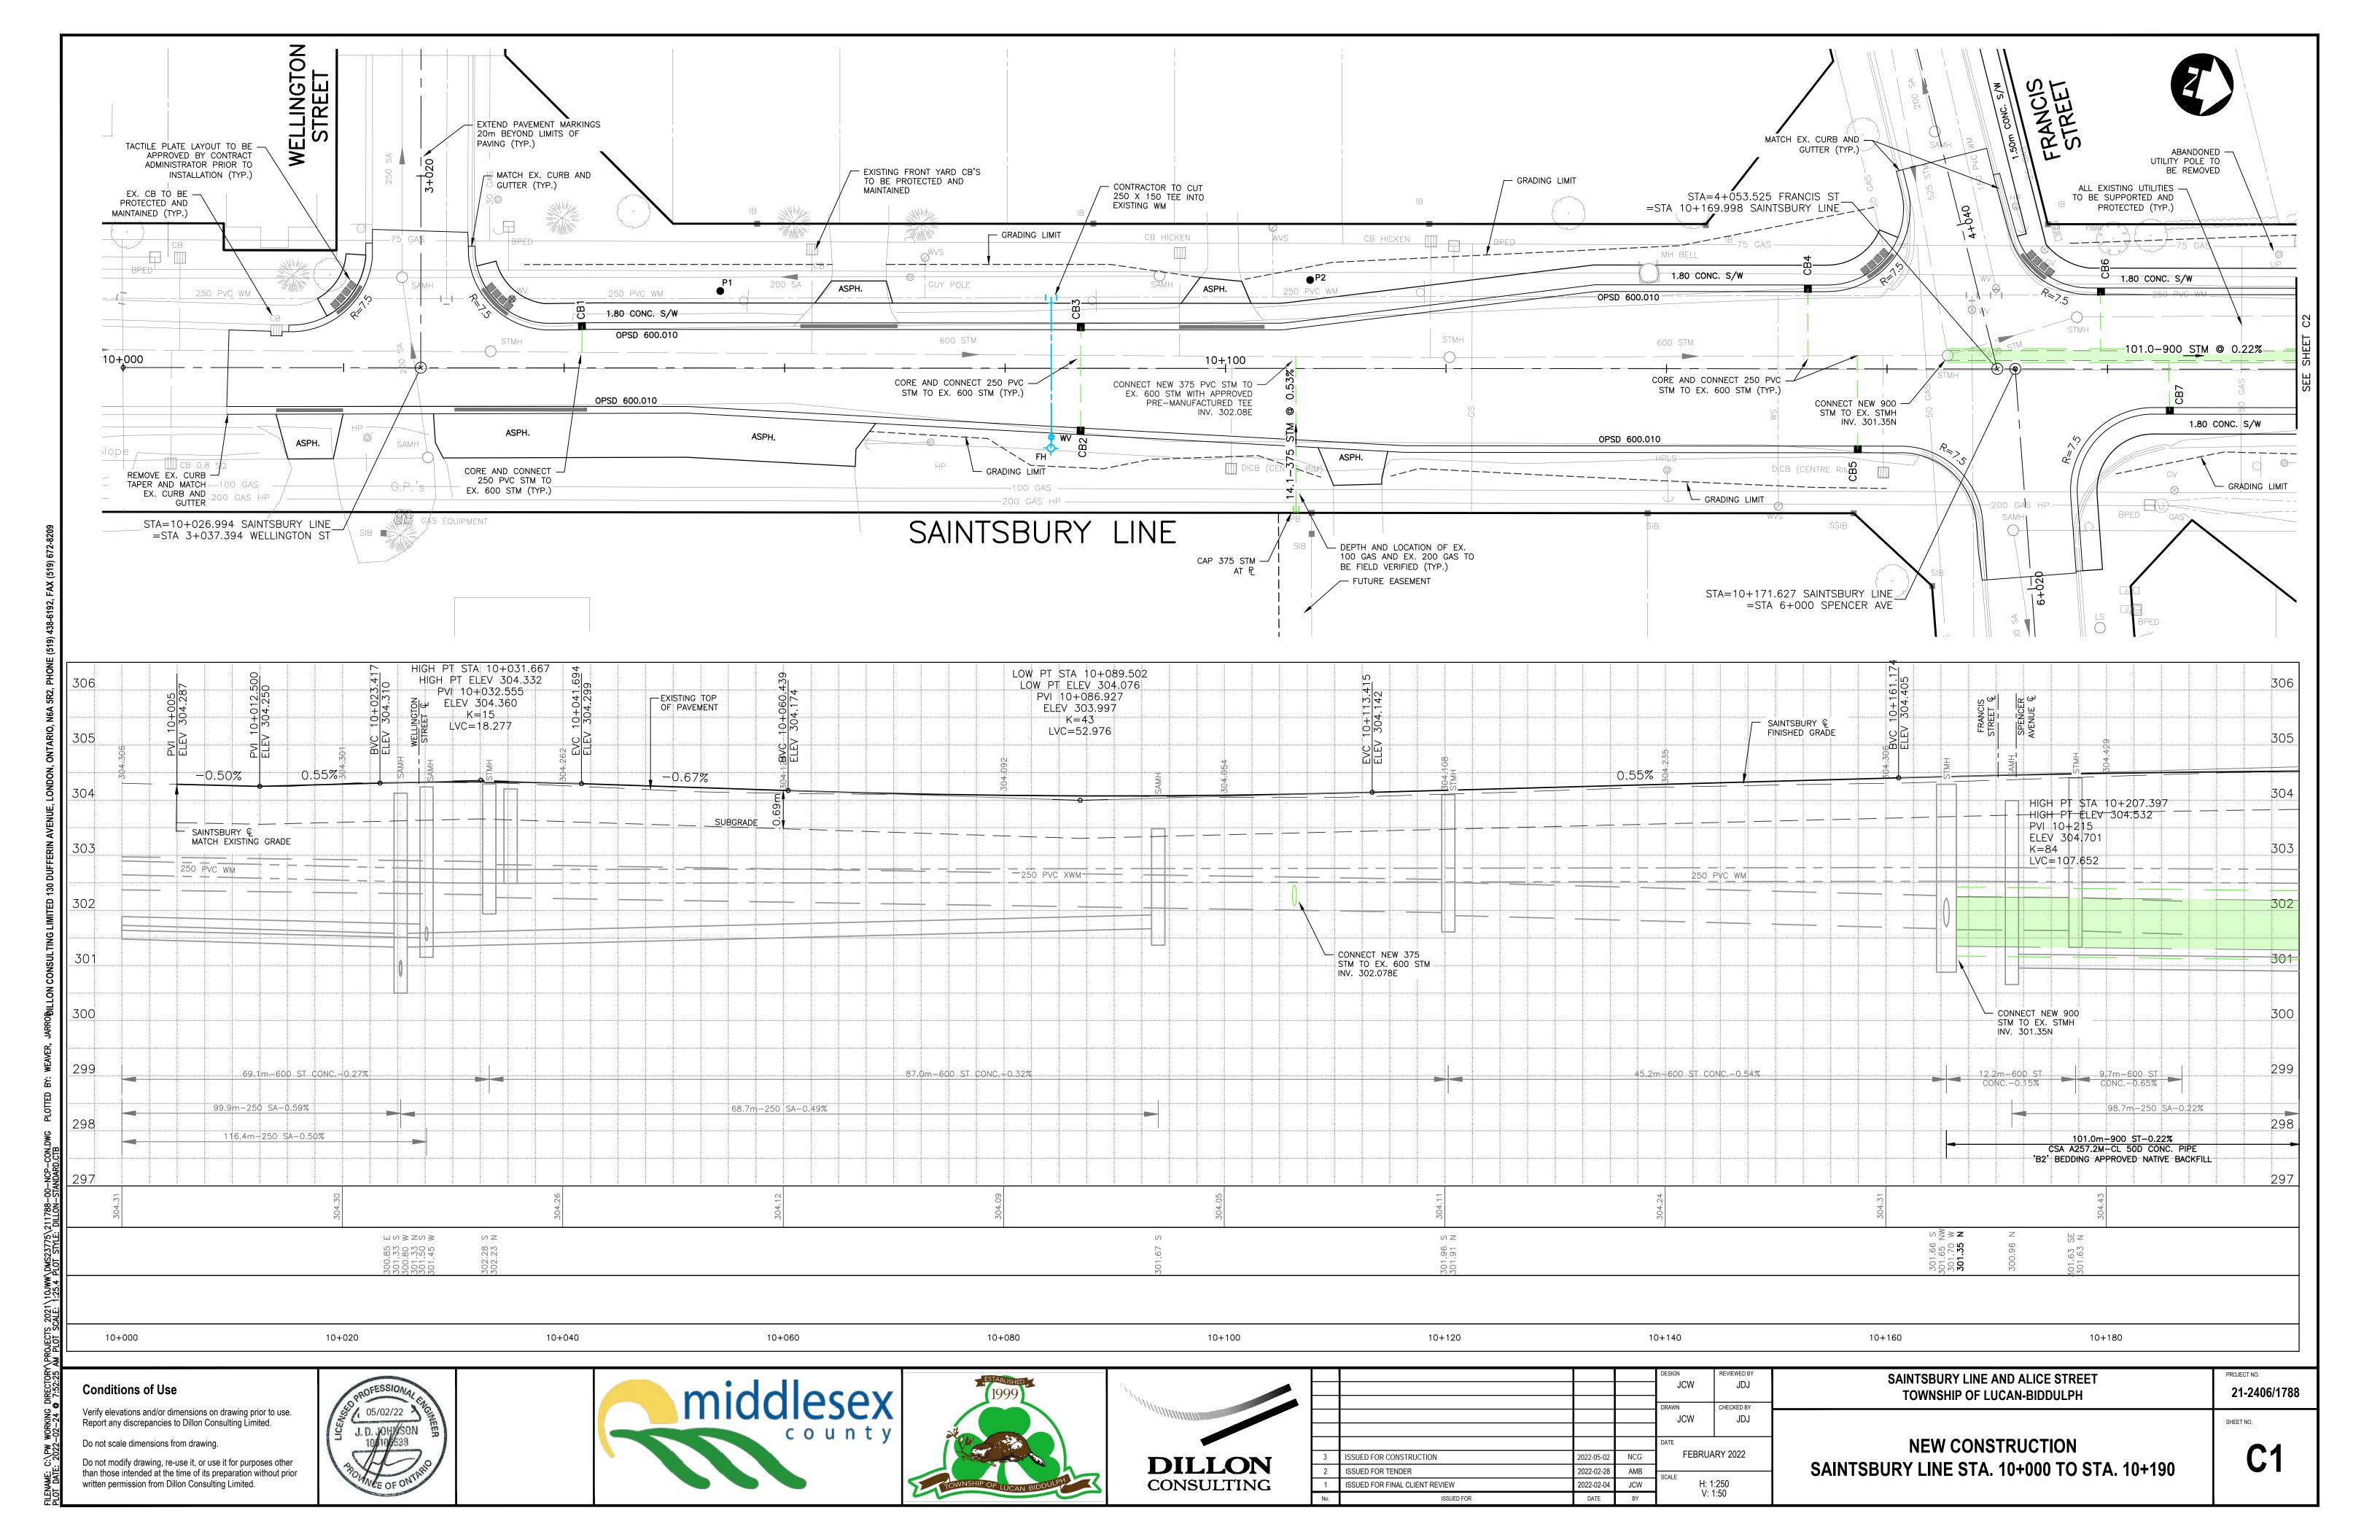






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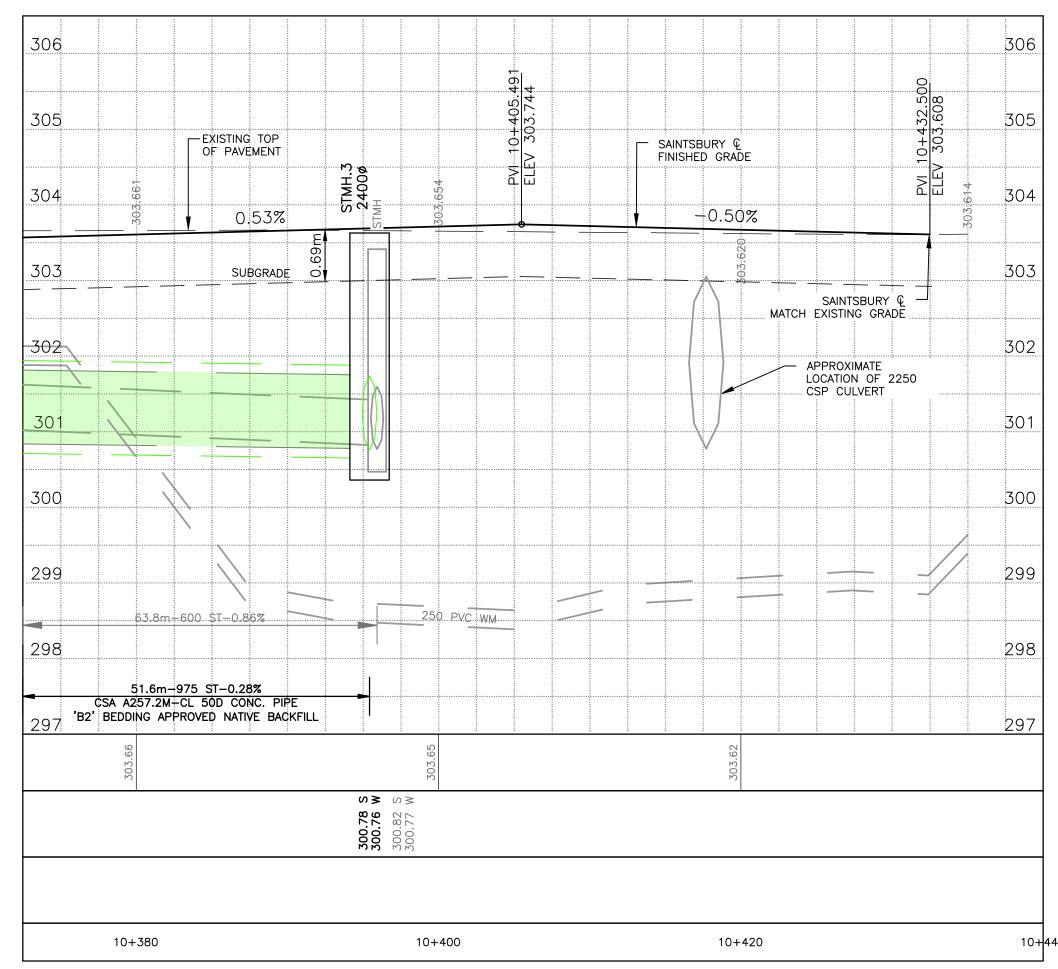
TOWNSHIP OF LUCAN-BIDDULPH	21-2406/1788
	SHEET NO.
REMOVALS ALICE STREET STA. 10+230 TO STA. 10+420.110	R4


SAINTSBURY LINE AND ALICE STREET

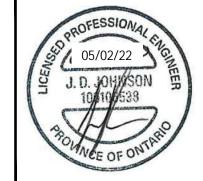




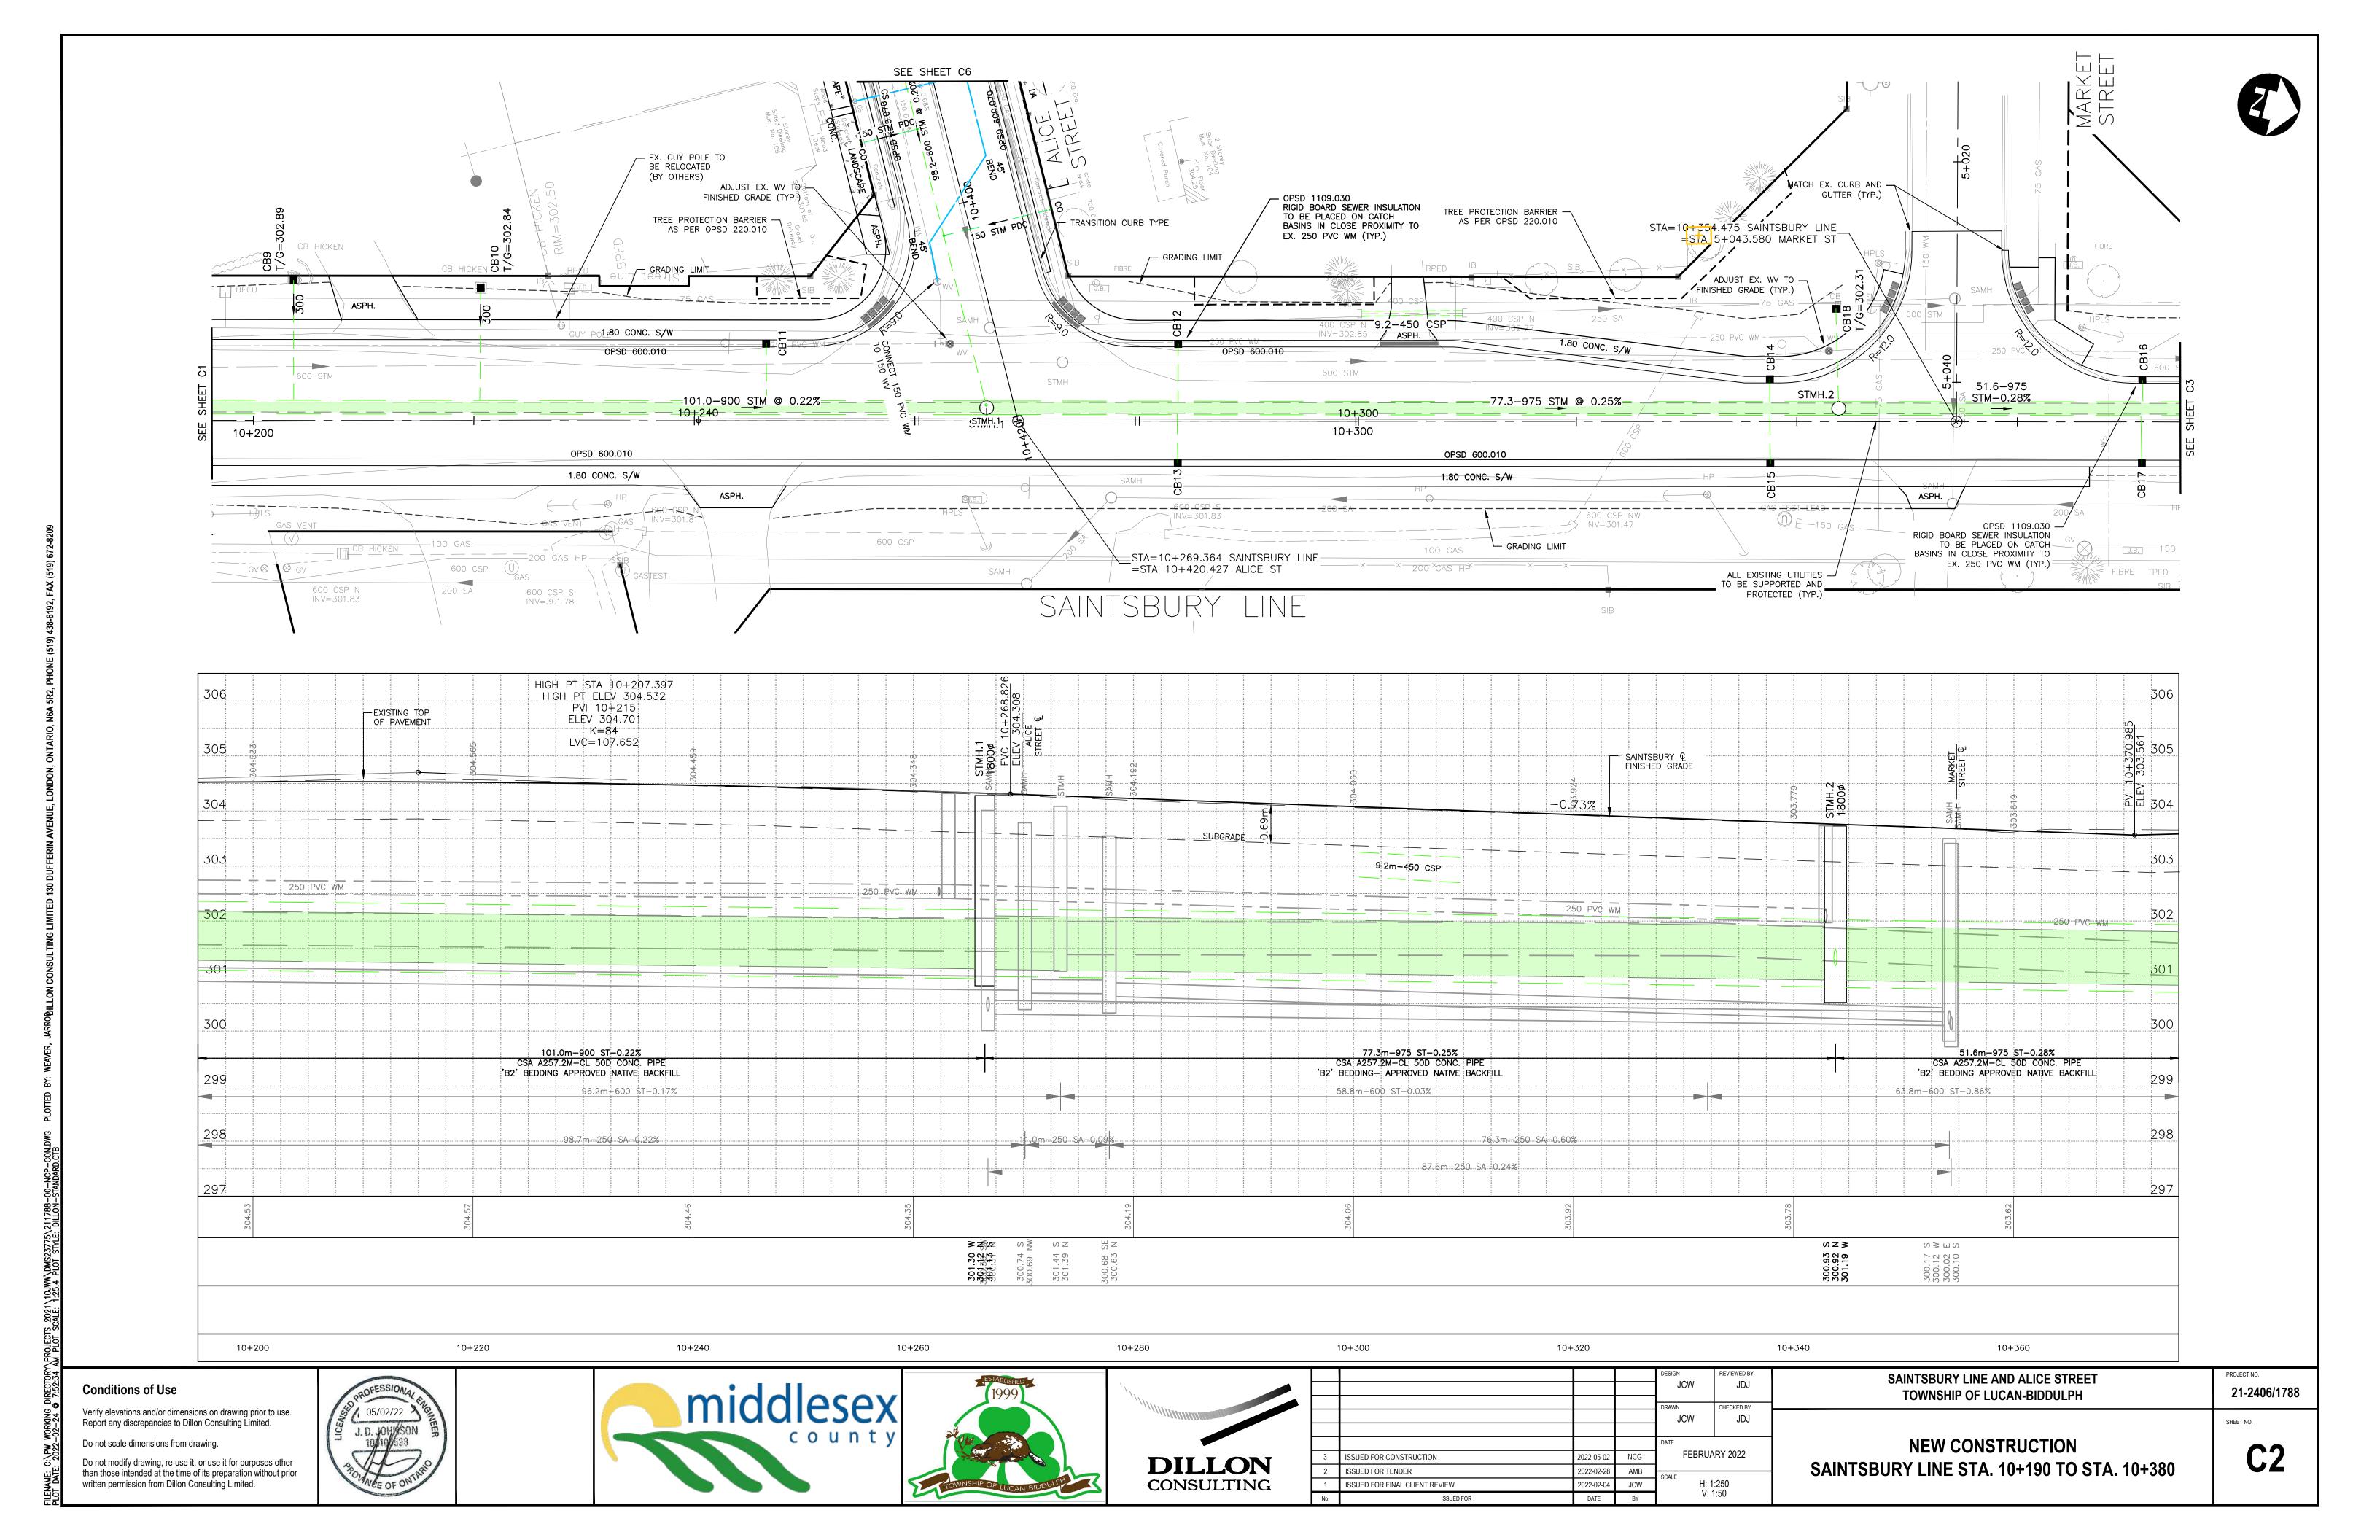

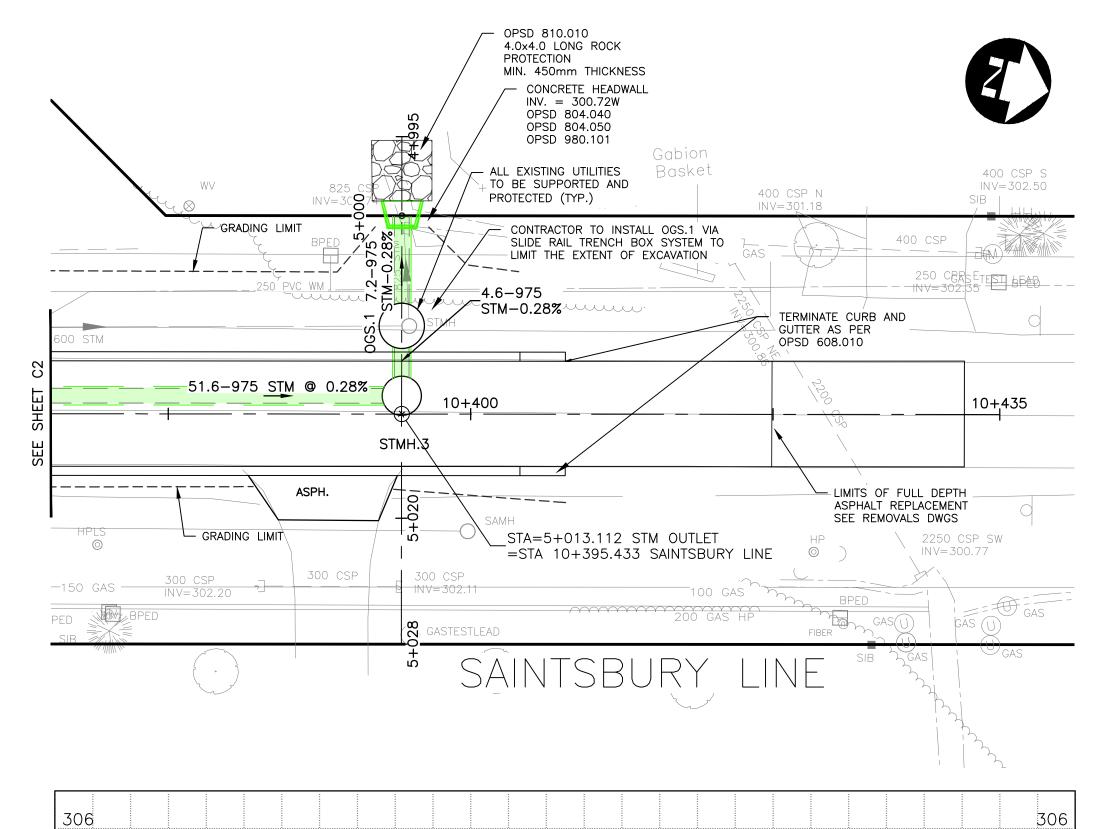

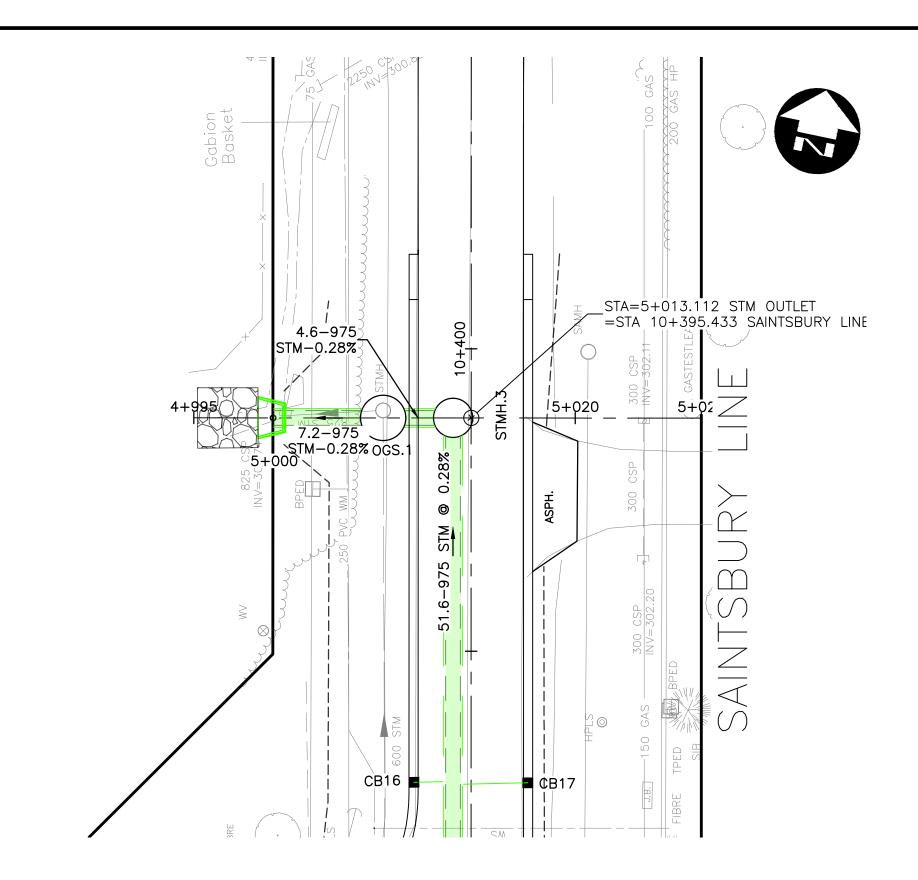

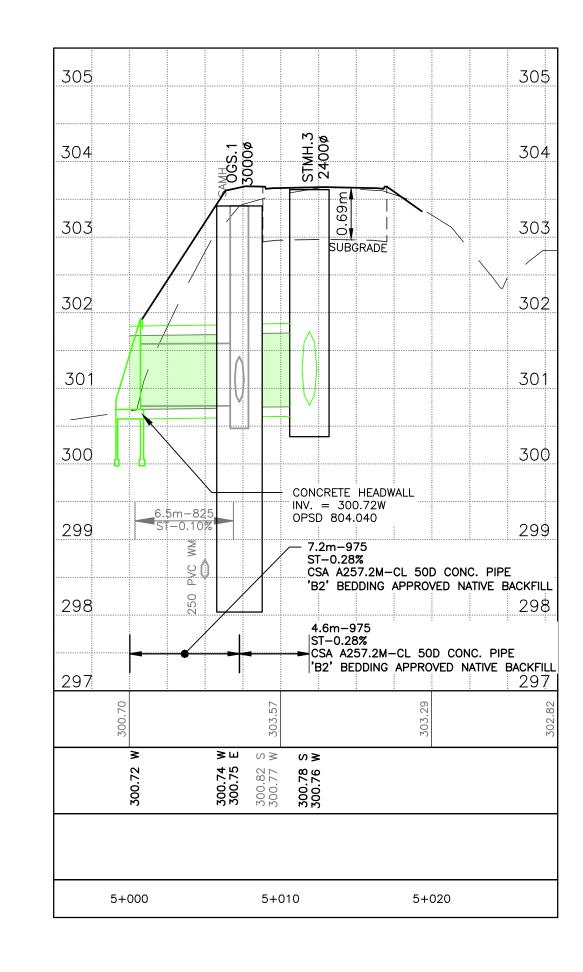

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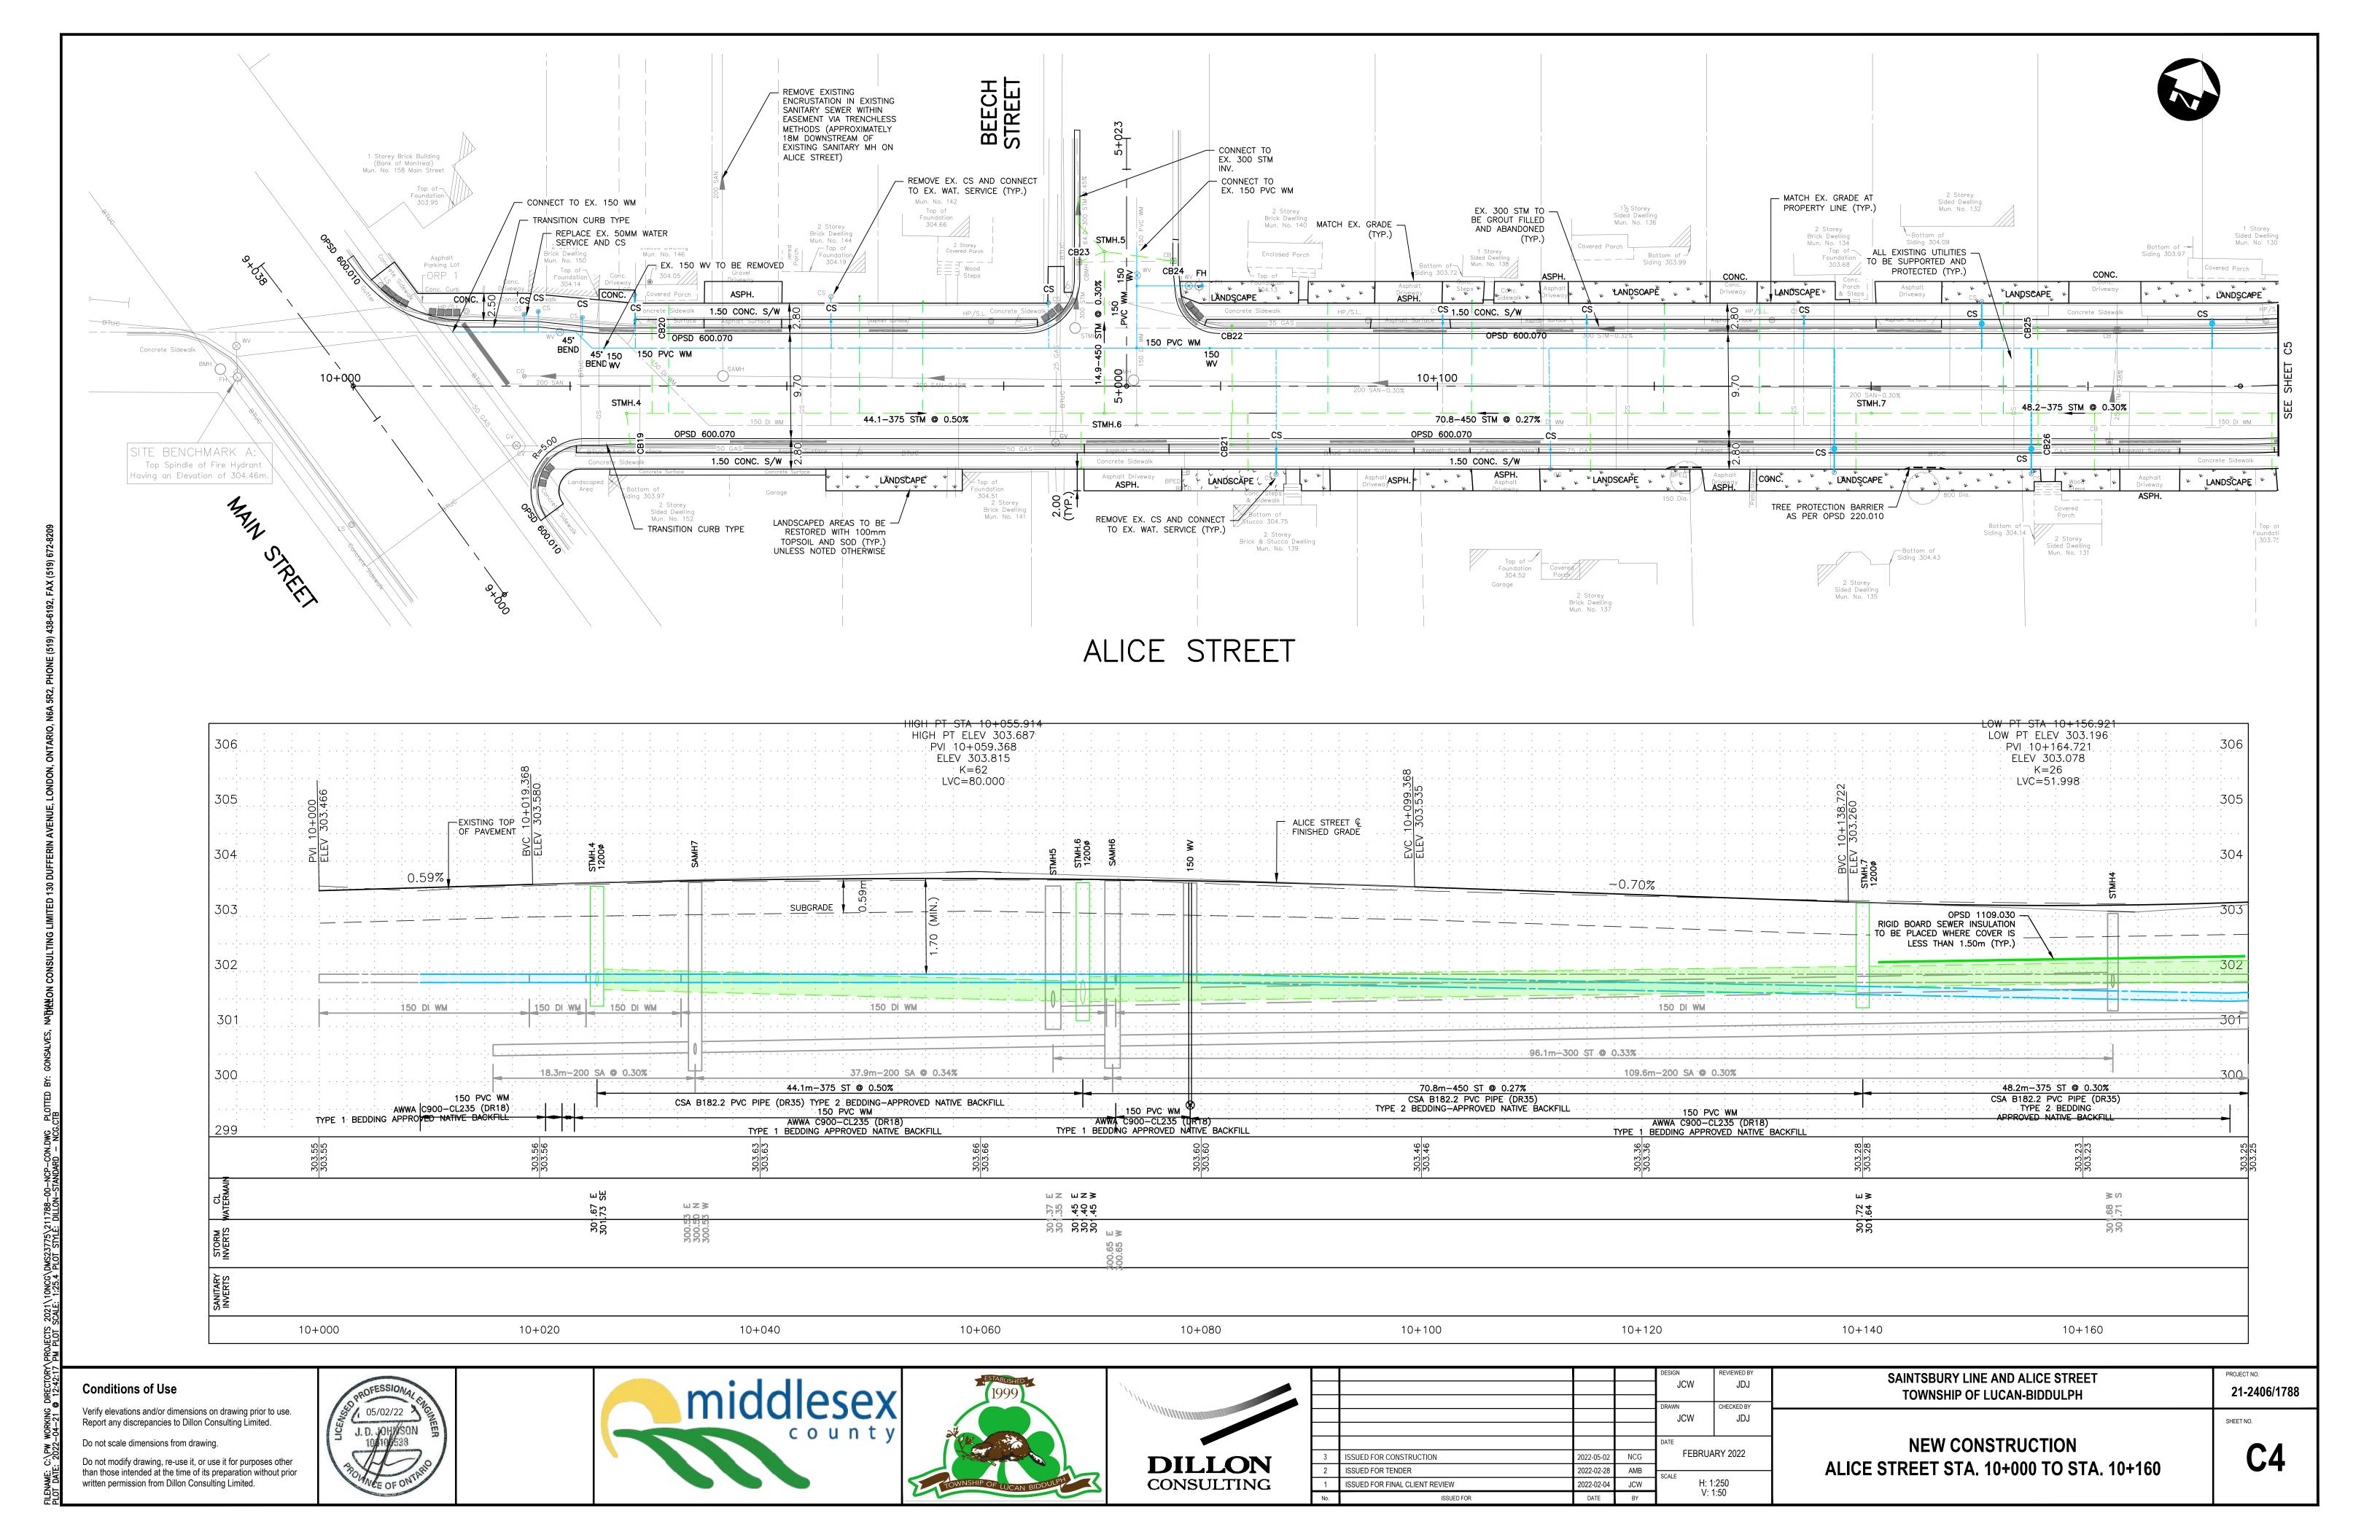


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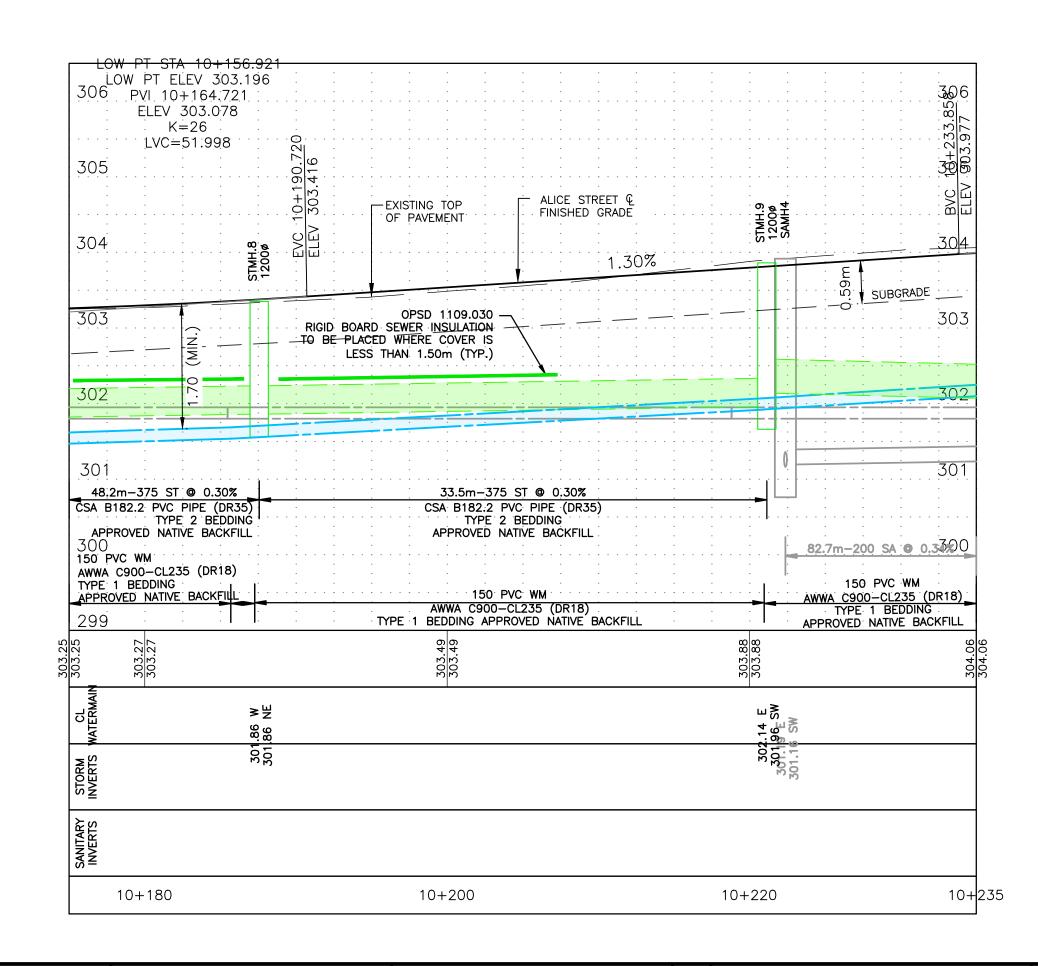
SHEET NO. **NEW CONSTRUCTION** SAINTSBURY LINE STA. 10+380 TO STA. 10+420

SAINTSBURY LINE AND ALICE STREET

TOWNSHIP OF LUCAN-BIDDULPH



# ALICE STREET



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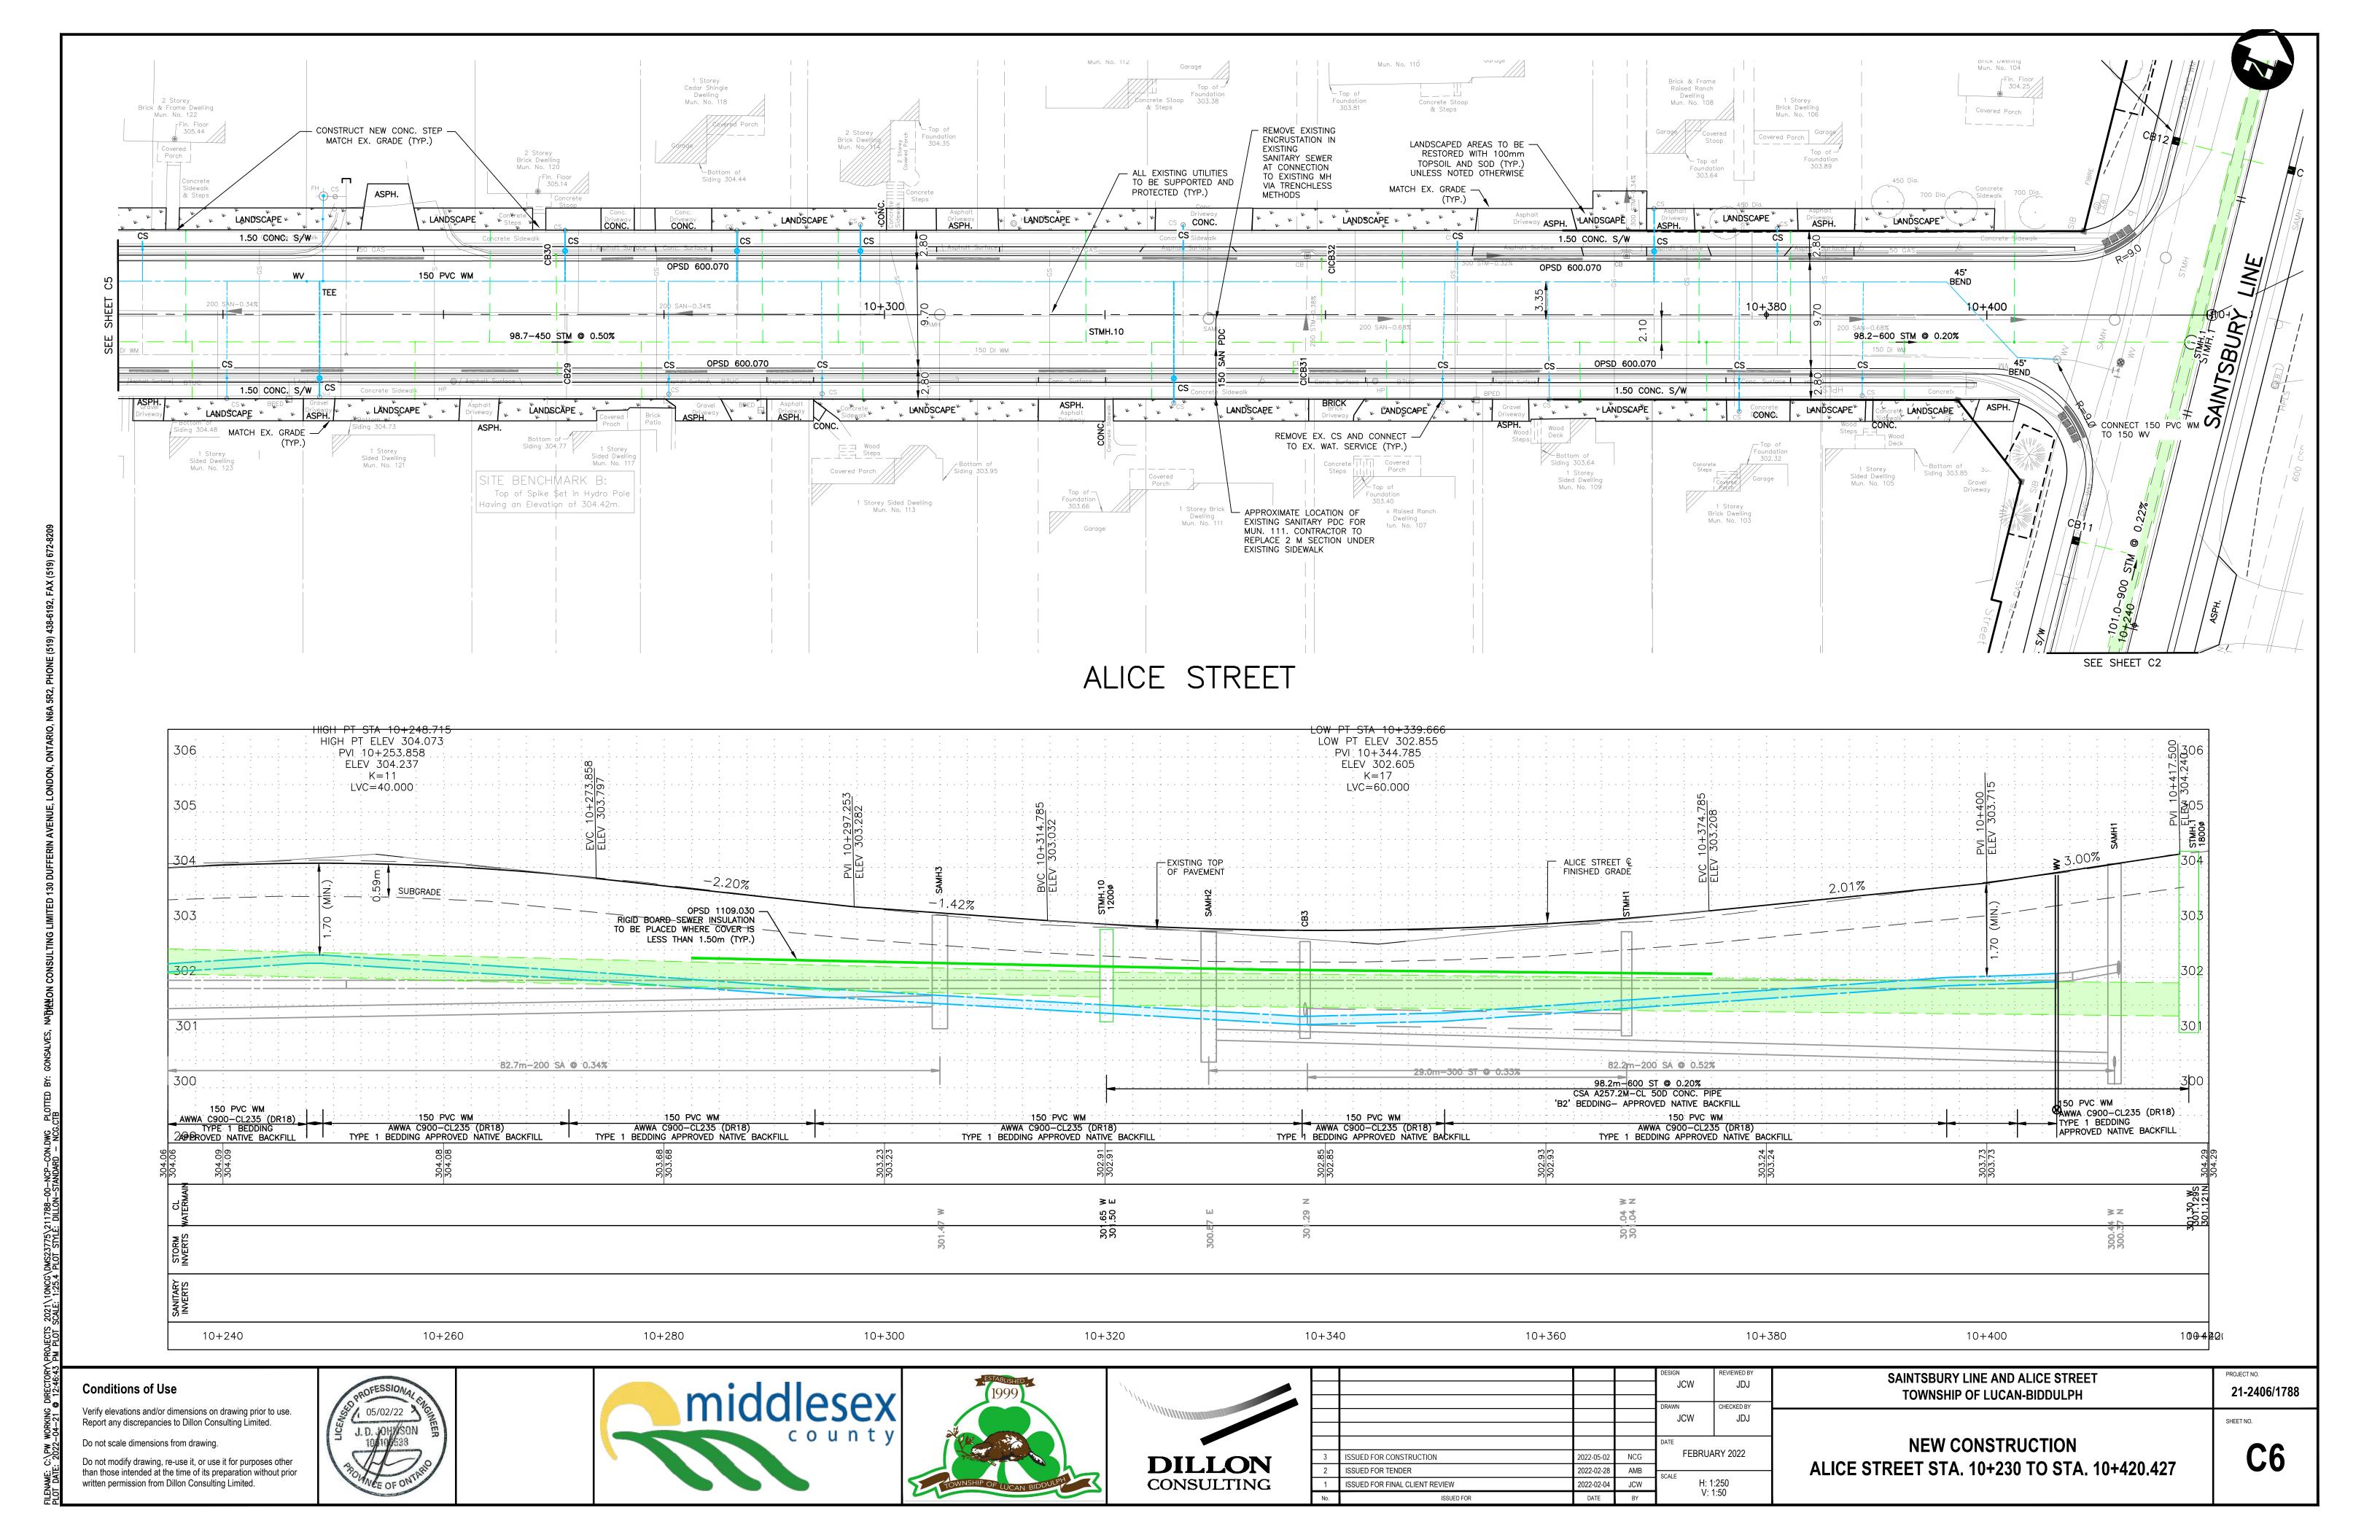
TOWNSHIP OF LUCAN-BIDDULPH							

SAINTSBURY LINE AND ALICE STREET

NEW CONSTRUCTION ALICE STREET STA. 10+160 TO STA. 10+230

C5

SHEET NO.





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TYPICAL SECTIONS
SAINTSBURY LINE STA.
10+230

21-2406/1788

TS1

SHEET NO.

SAINTSBURY LINE AND ALICE STREET

TOWNSHIP OF LUCAN-BIDDULPH



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1	ISSUED FOR FINAL CLIENT REVIEW	2022-02-04	JCW		50	
No.	ISSUED FOR	DATE	BY	1:		

TYPICAL SECTIONS
SAINTSBURY LINE STA.
10+300

21-2406/1788

TS2

SHEET NO.

SAINTSBURY LINE AND ALICE STREET

TOWNSHIP OF LUCAN-BIDDULPH

. - . . - -0.80m BLVD CONC. SW 3.50M LANE WIDTH 3.50M LANE WIDTH 2:70m PARKING ALICE STREET CONC CURB AND GUTTER OPSD 600.040 (TYP. BOTH SIDES) 40mm HL3 SURFACE ASPHALT (2x50mm) HL8 BINDER ASPHALT EXISTING T 150mm GRANULAR 'A' FINISHED 300mm GRANULAR 'B' (TYP.) -2.0% -2.0% CONNECT TO EX. WAT. SERVICE CONNECT TO EX. INSULATE WAT. SERVICES— WHERE COVER IS LESS THAN 1.7m (TYP.) 50 PEX WS EX. 150
150 WM TO BE
CI WM REMOVED/GROUTED EX. 300 STM TO BE REMOVED/GROUTED

0

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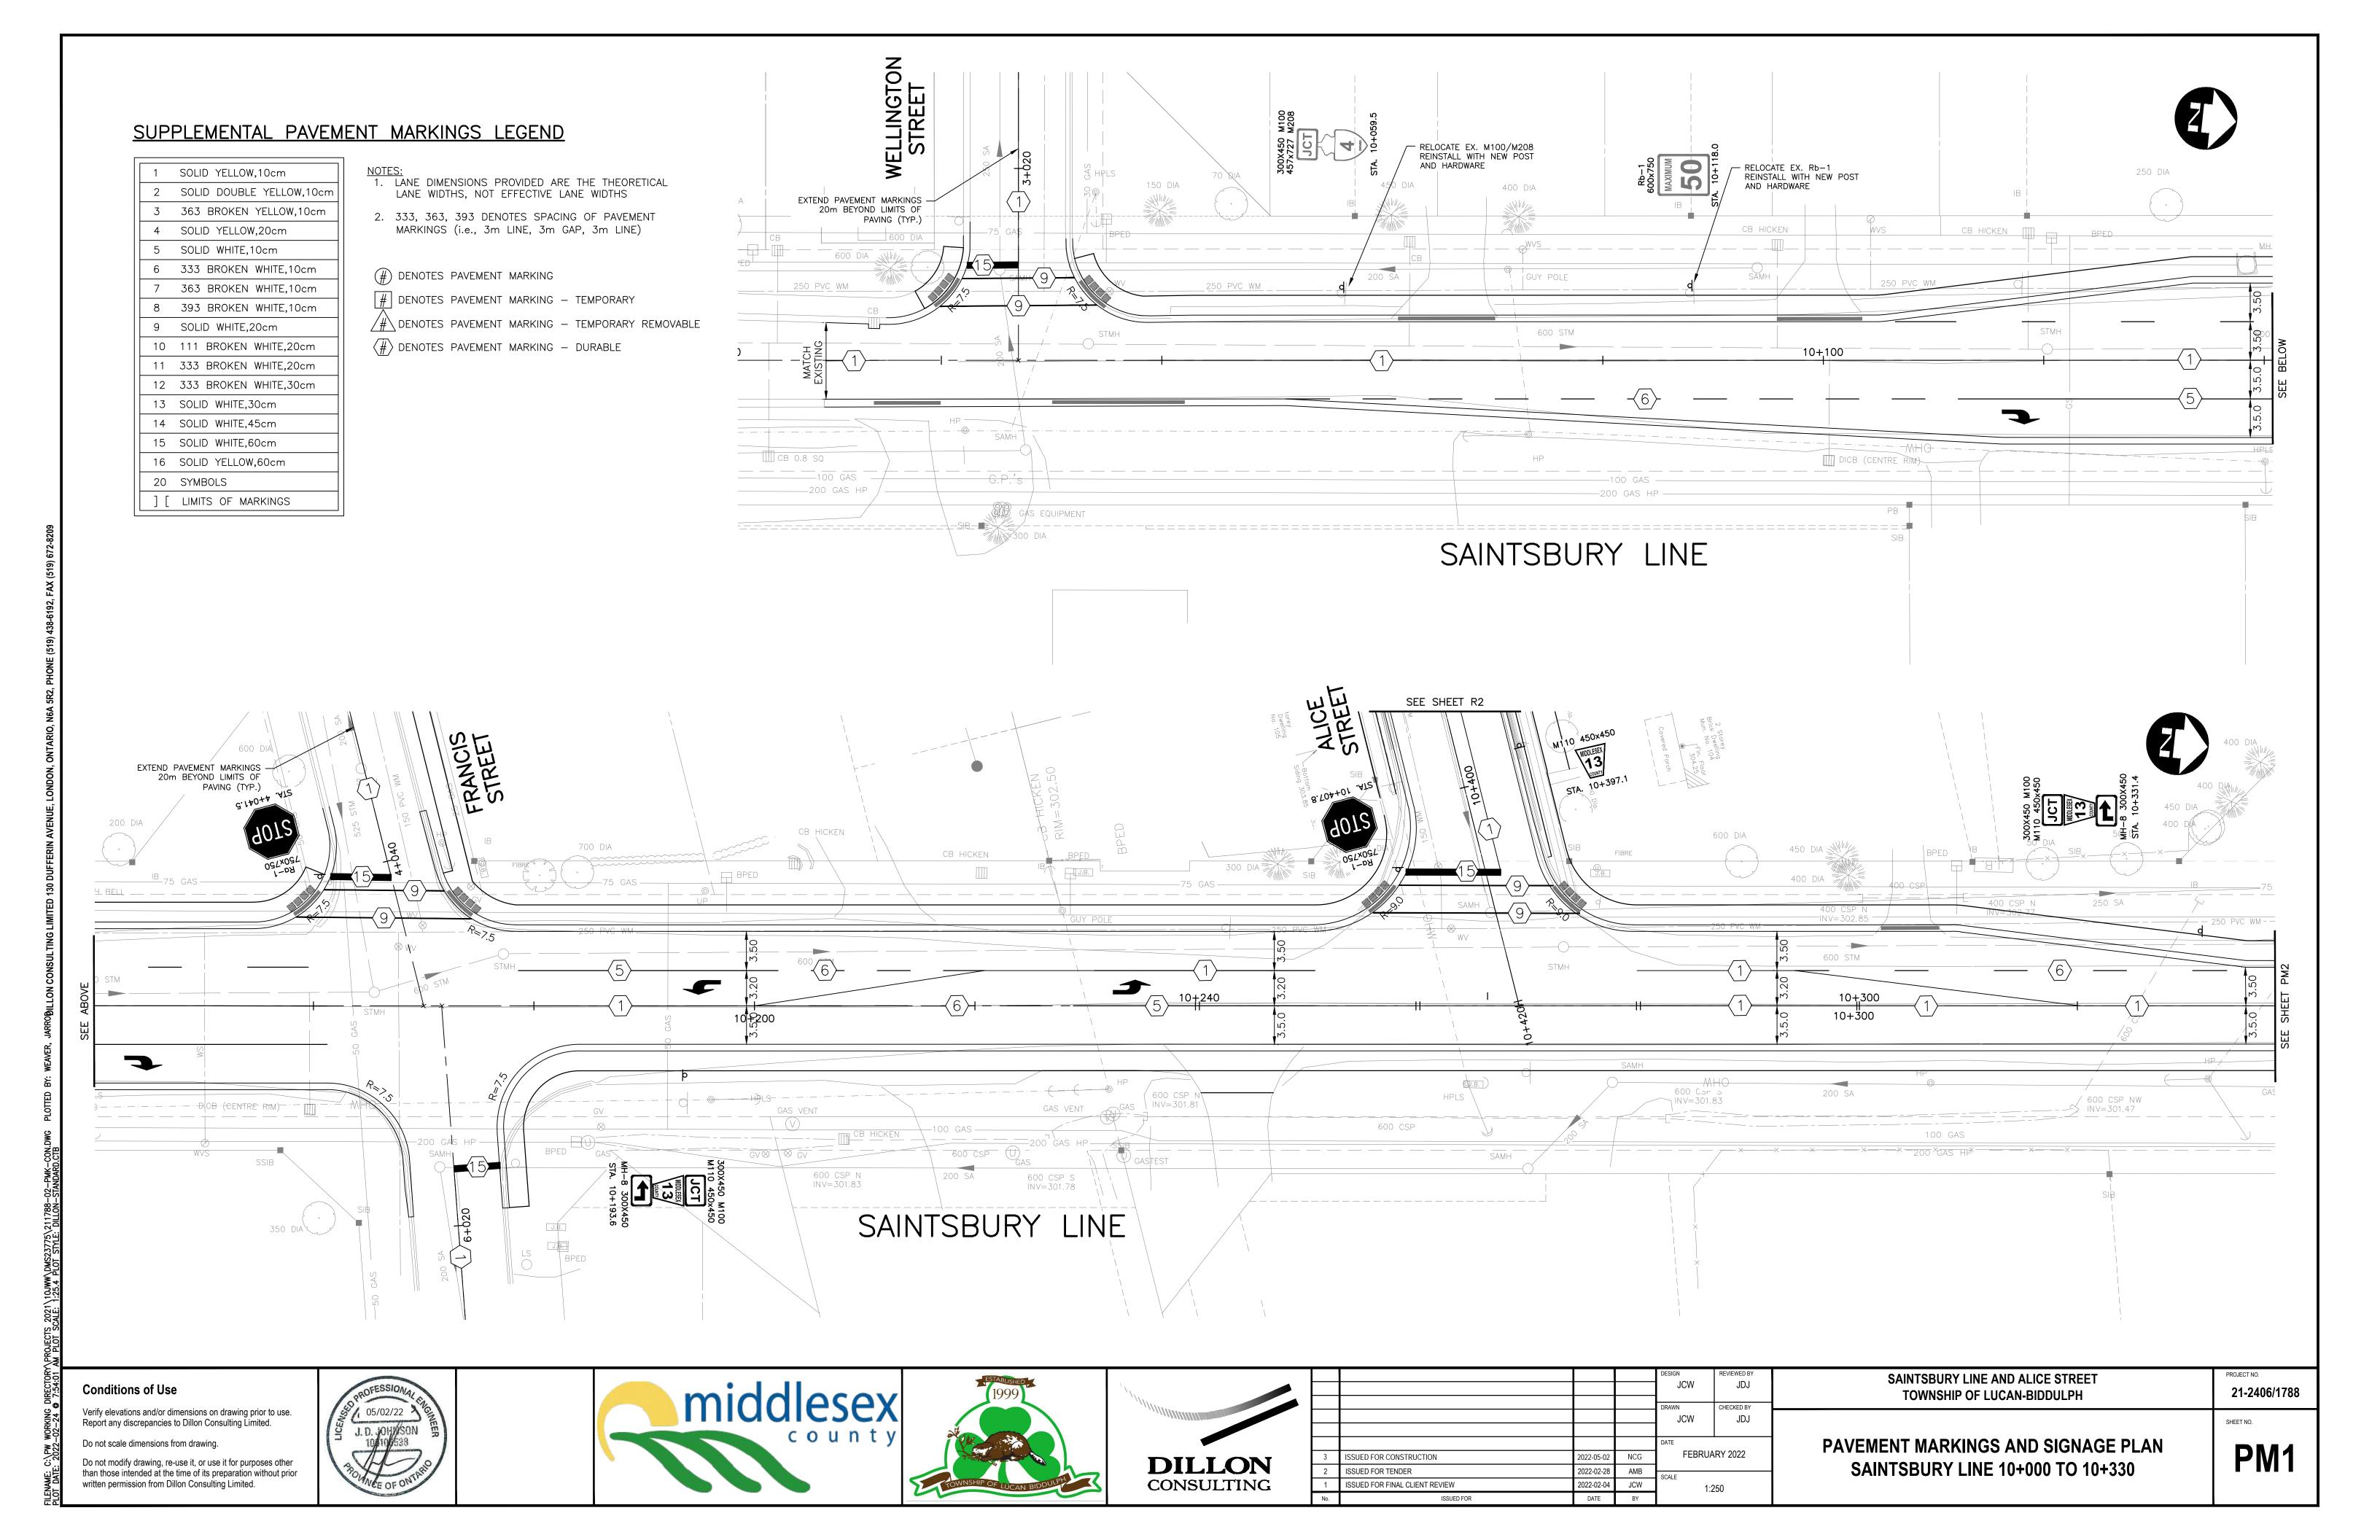
TYPICAL SECTIONS
ALICE STREET. STA. 10+085


21-2406/1788

TS3

SAINTSBURY LINE AND ALICE STREET

TOWNSHIP OF LUCAN-BIDDULPH



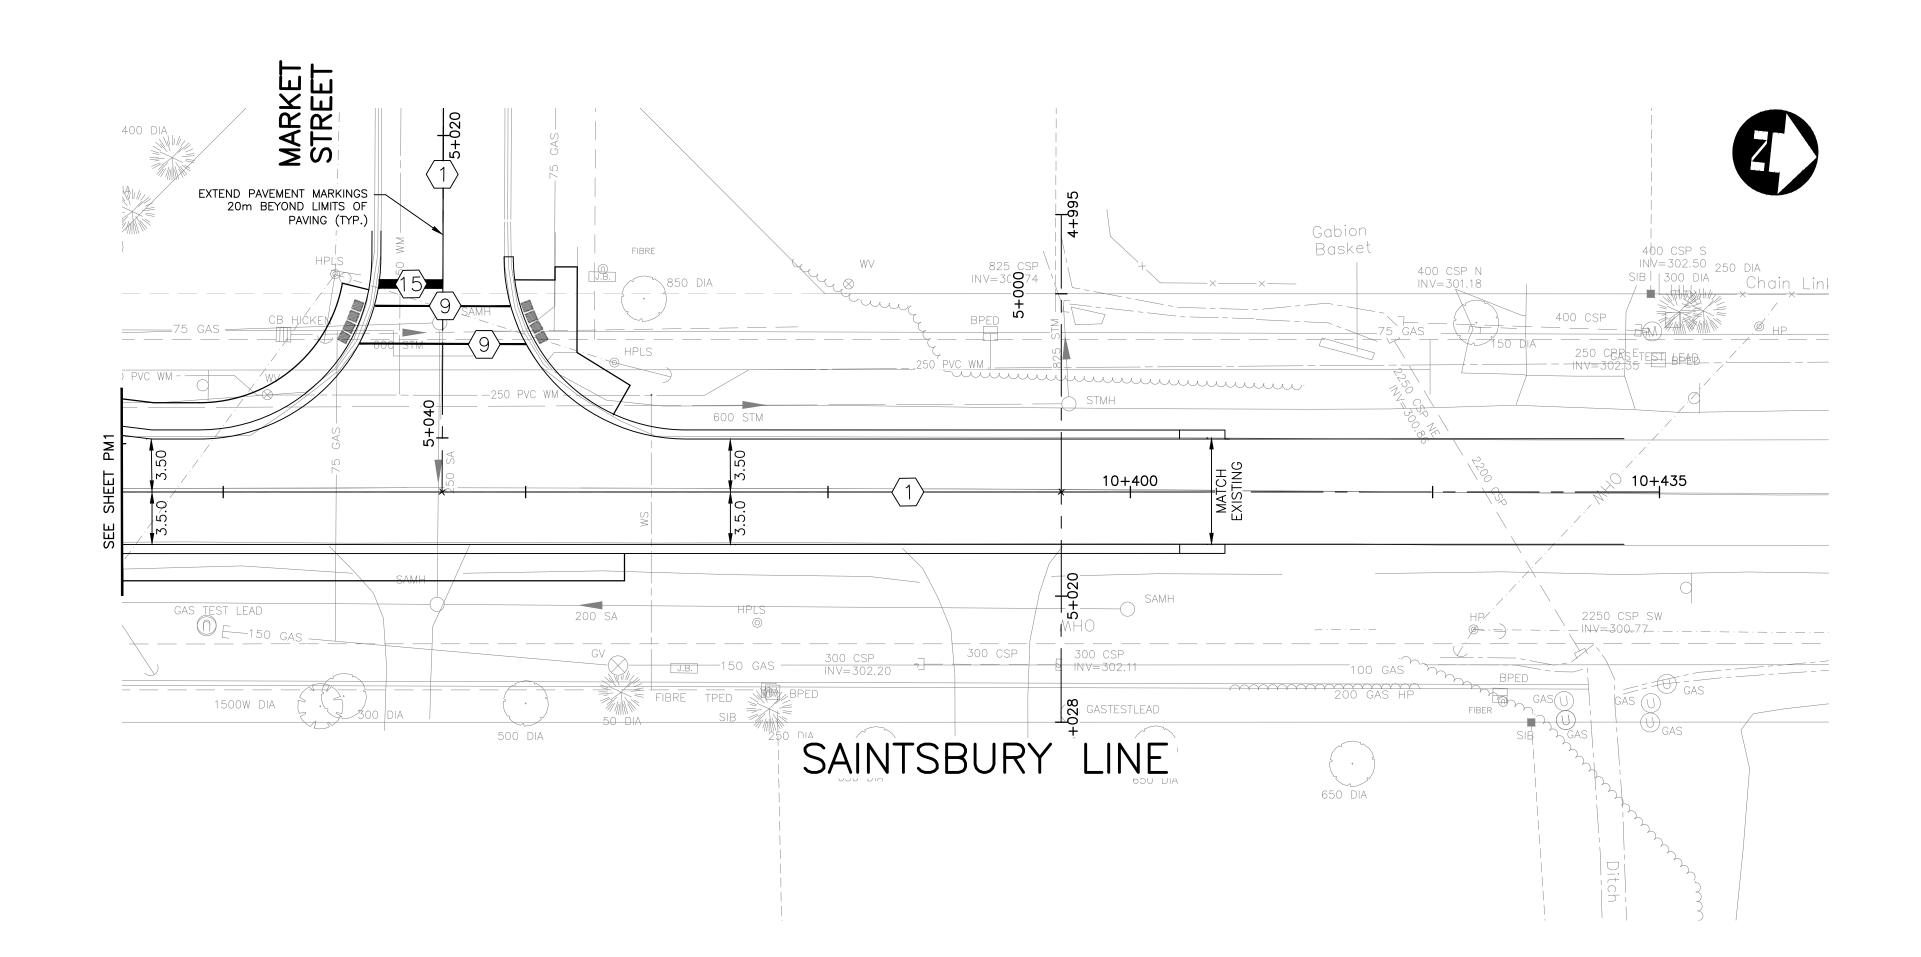

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1	ISSUED FOR TENDER ISSUED FOR FINAL CLIENT REVIEW	2022-02-28 2022-02-04	AMB JCW	SCALE 1:2	250
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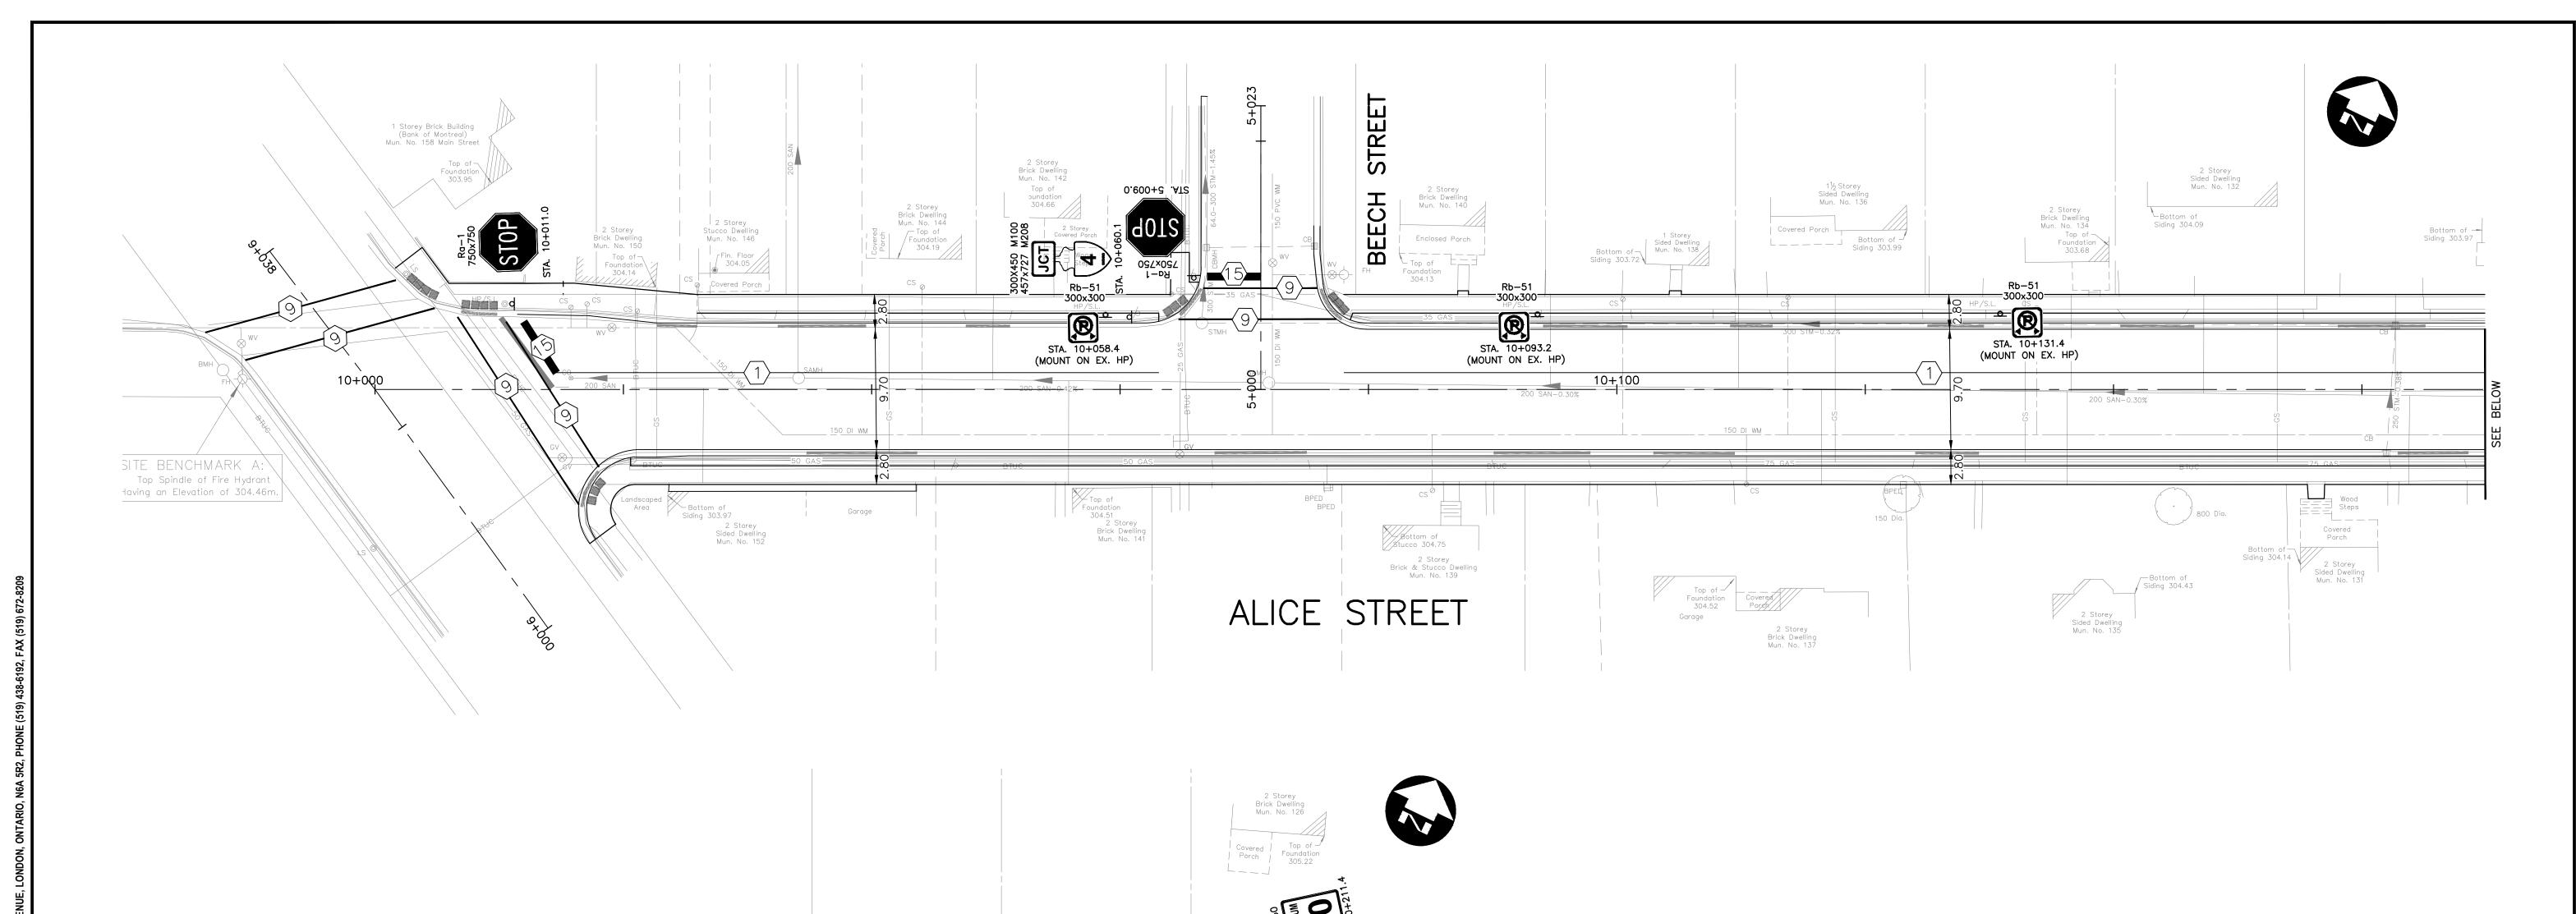
TOWNSHIP OF LUCAN-BIDDULPH	
PAVEMENT MARKINGS AND SIGNAGE PLAN	
SAINTSBURY LINE 10+330 TO STA. 10+420.110	


SAINTSBURY LINE AND ALICE STREET

PM2

21-2406/1788

SHEET NO.



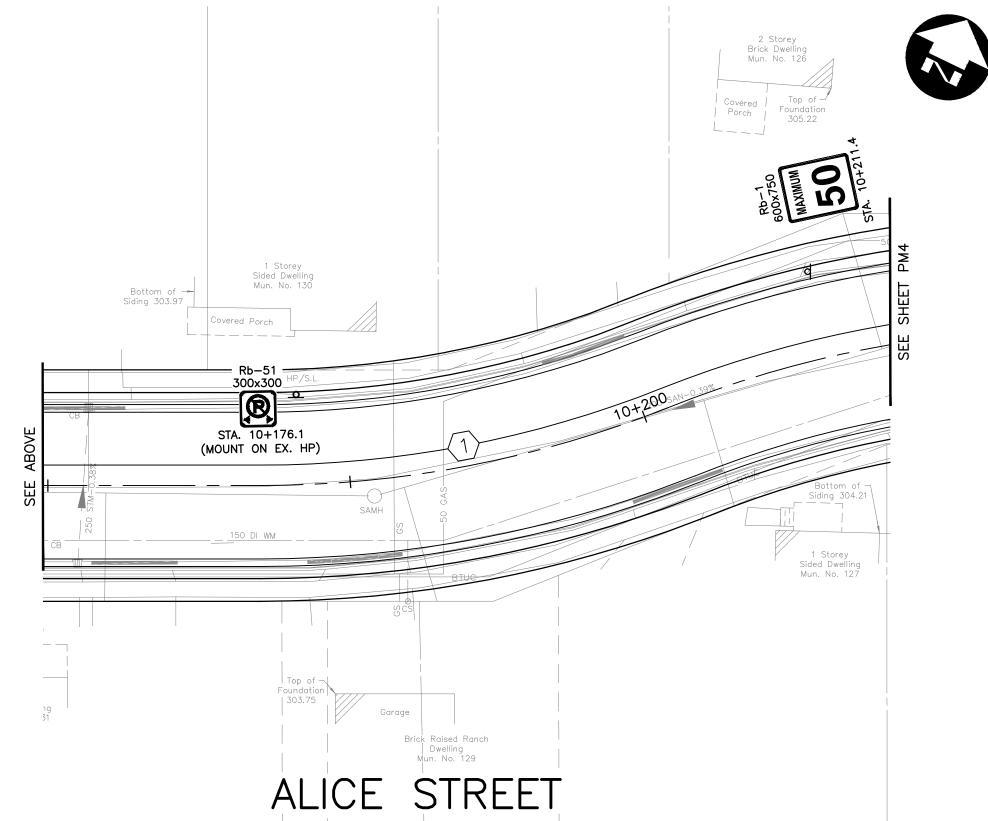

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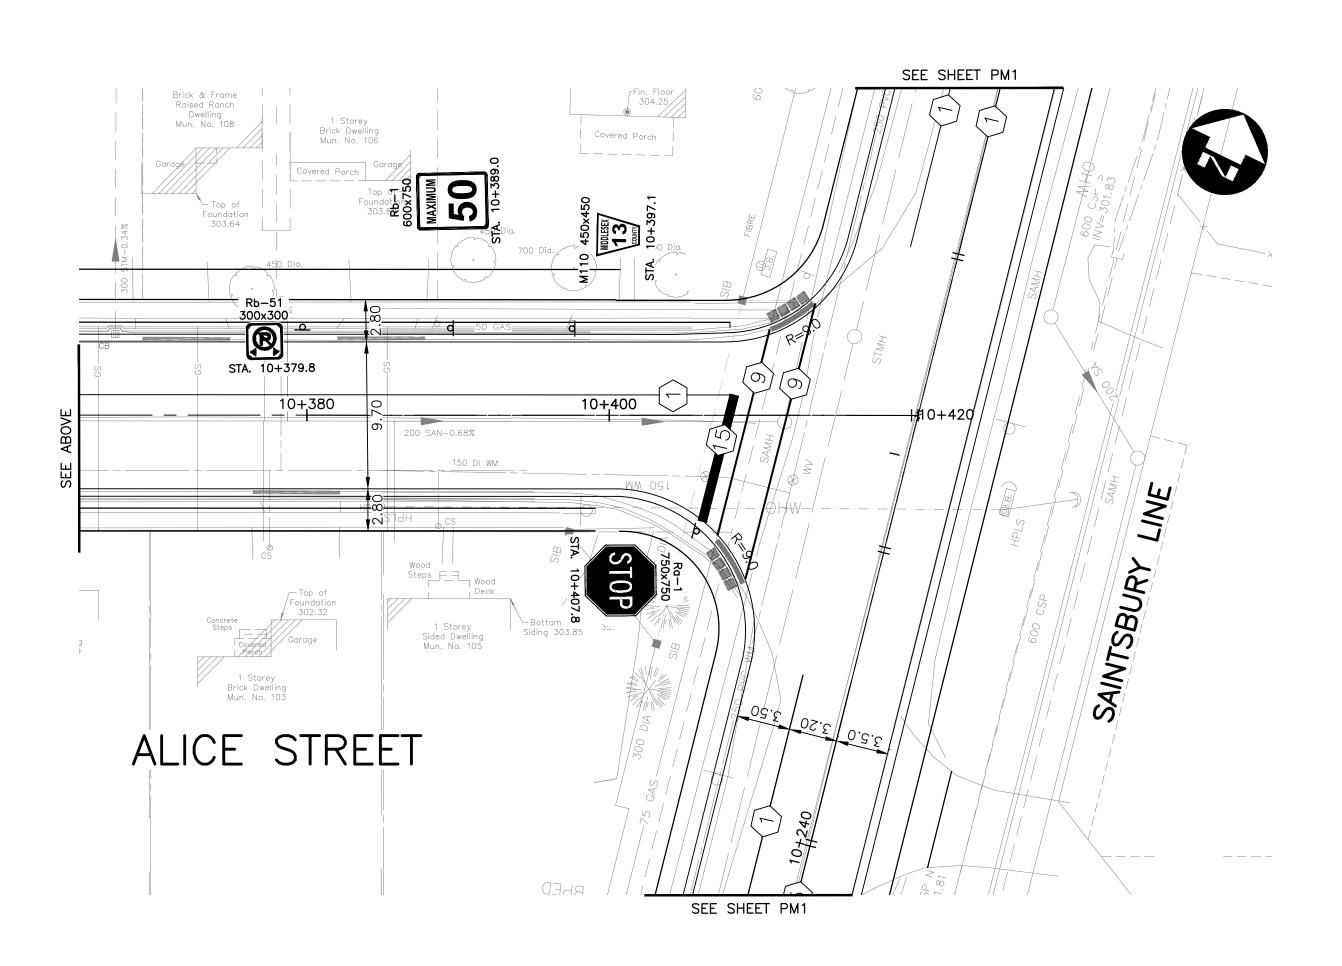
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1	ISSUED FOR FINAL CLIENT REVIEW	FOR FINAL CLIENT REVIEW 2022-02-04		1.2	250	
No.	ISSUED FOR	DATE	BY			

SAINTSBURY LINE AND ALICE STREET TOWNSHIP OF LUCAN-BIDDULPH	

PAVEMENT MARKINGS AND SIGNAGE PLAN ALICE STREET STA. 10+000 TO STA. 10+230

PM3

SHEET NO.



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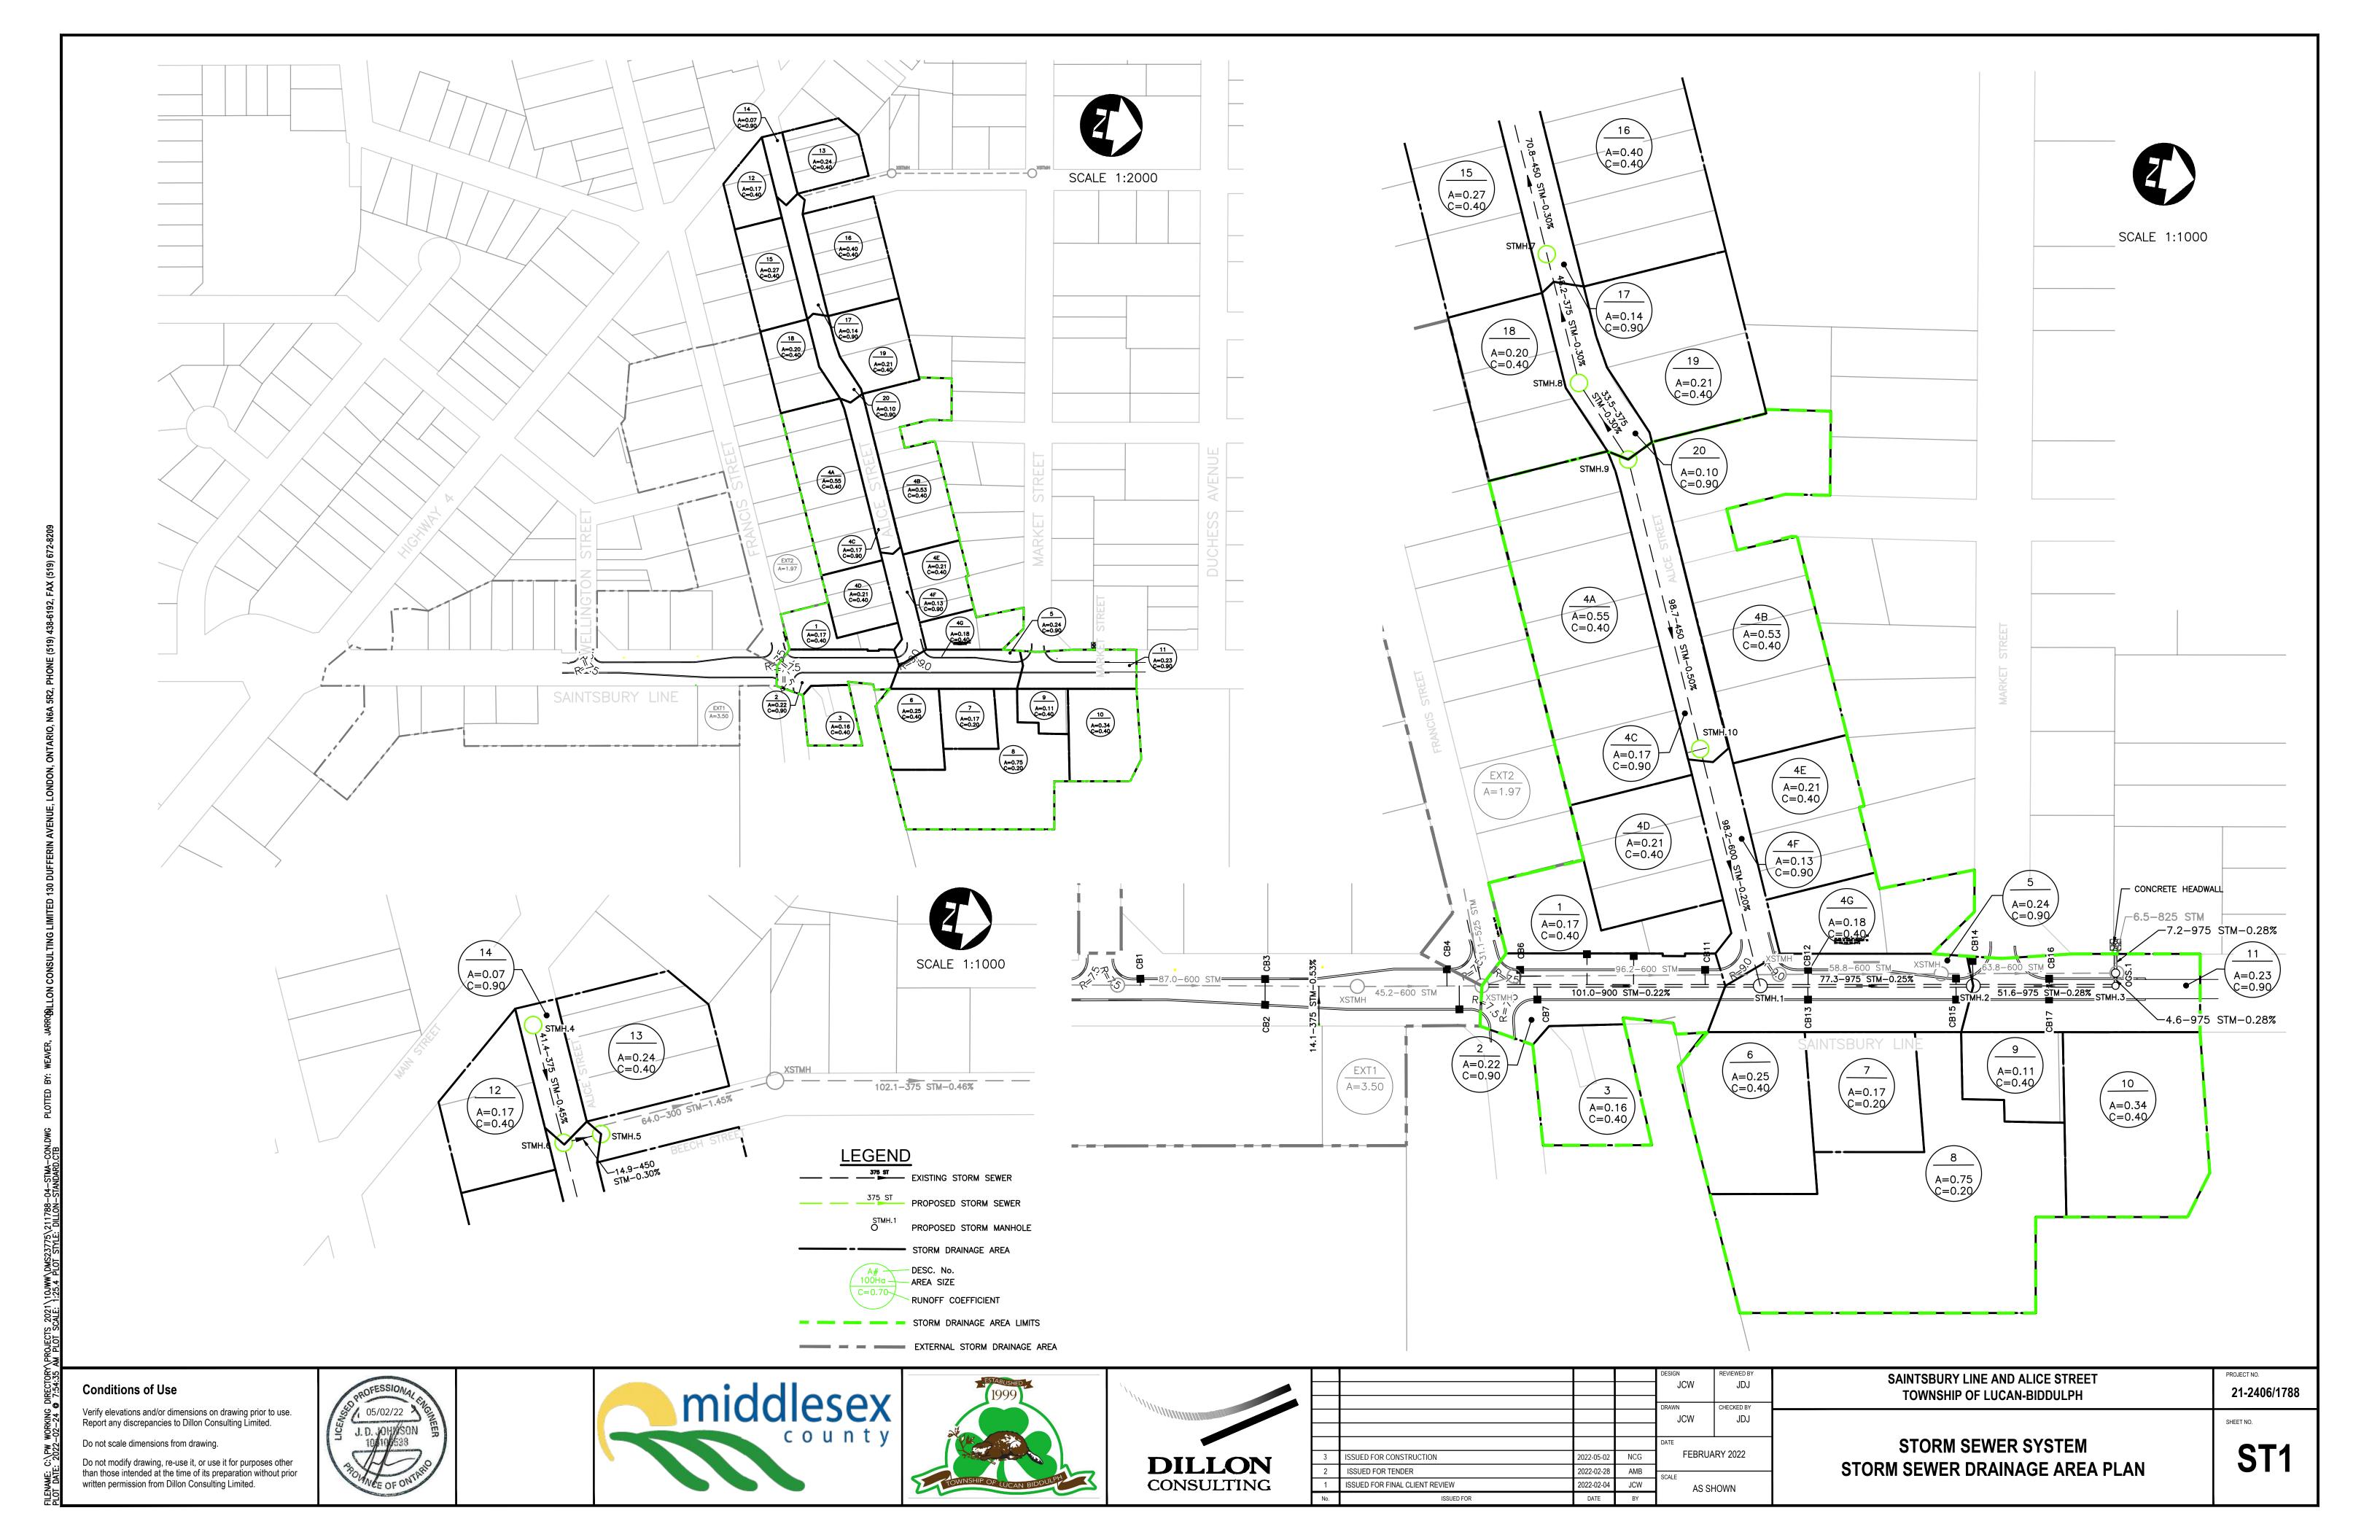
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	2	ISSUED FOR TENDER	2022-02-28	AMB			
	1	ISSUED FOR FINAL CLIENT REVIEW	2022-02-04	JCW	1.2	.50	
	No.	ISSUED FOR	DATE	BY			

PAVEMENT MARKINGS AND SIGNAGE PLAN ALICE STREET STA. 10+230 TO STA. 10+420.427

SAINTSBURY LINE AND ALICE STREET

TOWNSHIP OF LUCAN-BIDDULPH

PM4



DENSELY BUILT, PAVED

THE FOLLOWING 'C' VALUES WILL APPLY WHEN DESIGNING STORM SEWERS:

PARKS, OPEN SPACE
SINGLE FAMILY/SEMI DETACHED
TOWNHOUSE/ROWHOUSE
APARTMENTS
COMMERCIAL, INSTITUTIONAL & INDUSTRIAL

0.20 0.50 - 0.55 0.65 0.65 - 0.70 0.70 - 0.90 WHERE Q = PEAK FLOW IN LITRES PER SECOND (L/sec)
A = AREA IN HECTARES (Ha)
C = RUNOFF COEFFICIENT
I = RANIFALL INTENSITY (mm/hr)
RETURN PERIOD = 2 YEARS

FLOW Q=2.78 x C x A x I

DATE: 28-Feb-22

DESIGNED BY: JCW

PROJECT NAME:

0.90

Alice Street and Saintsbury Line Storm Sewer, Township of Lucan-Biddulph

PROJECT FILE NO.: 211788/212406

				PROJ	ECT NAME:				Alice Str	reet and Sa	intsbury Lin	e Storm Sev	wer, Iowns	hip of Lucar	n-Biddulph				•			PROJEC	T FILE NO.:		1788/21240	10	
	LOCATION	N .			REA			TOTAL	<u> </u>	:				INTENSITY					EWER DESIG						PROFILE		
Area No.	Street	From Manhole	To Manhole	Delta Hectares	Total Hectares	С	AxC	Total Section	Total Lateral	Total Sewer	Total 2.78AxC	Time En	try (min) Accum.	Intensity mm/hr	Q L/sec	n	Pipe Size mm	Slope %	Capacity L/sec	Velocity m/sec	Length m	Time of Flow	Fall in Sewer	Headloss	Drop in U.S. M.H.	Invert El U.S.	levation D.S.
EXT1	Saintsbury Line	1 TO III III III III III III	. o mainiole	3.50	3.50		7.00	2.37		30,1101	6.59	1.17	23.40	67.36	443.81	0.013	600	0.65	495.03	1.75	43.90	0.42	0.285		0.010		
EXT2	Francis Street			1.97	1.97	0.60	1.18	1.18			3.29	24.33	47.73	39.77	130.68	0.013	600	0.65	495.03	1.75	43.90	0.42	0.285		0.010		
1	Saintsbury Line			0.17	5.64	0.40	0.07	0.07			0.19																
2	Saintsbury Line			0.22	5.86	0.90	0.20	3.82			10.61																
2	-	XSTMH	STMH.1	0.16		0.40	0.06				10.79	0.40	23.82	66.59	718.67	0.013	000	0.00	040.44	4.22	101.00	1.06	0.000			204.250	204 420
3	Saintsbury Line	XSTMH	STIVIT.1		6.02			3.88			Maria	0.42	23.82	66.59	/18.6/	0.013	900	0.22	849.11	1.33	101.00	1.26	0.222			301.350	301.129
4A	Alice Street			0.55	0.55	0.40	0.22	0.22			0.61																
4B	Alice Street			0.53	1.08	0.40	0.21	0.43			1.20										-	+	-				
4C	Alice Street	STMH.9	STMH.10	0.17	1.25	0.90	0.15	0.59			1.63	19.00	19.00	76.56	124.51	0.013	450	0.50	201.60	1.27	98.70	1.30	0.494			302.140	301.647
4D	Alice Street			0.21	1.46	0.40	0.08	0.67			1.86																
4E	Alice Street			0.21	1.67	0.40	0.08	0.75			2.09																
4F	Alice Street	STMH.10	STMH.1	0.13	1.80	0.90	0.12	0.87			2.42	1.30	20.30	73.61	178.03	0.013	600	0.20	274.59	0.97	98.20	1.69	0.196		0.150	301.497	301.300
4G	Saintsbury Line			0.18	8.00	0.40	0.07	4.82			13.41																
5	Saintsbury Line			0.24	8.24	0.90	0.22	5.04			14.01																
6	Saintsbury Line			0.25	8.49	0.40	0.10	5.14			14.29																
7	Saintsbury Line			0.17	8.66	0.40	0.07	5.21			14.48																
8	Saintsbury Line	STMH.1	STMH.2	0.75	9.41	0.20	0.15	6.23			17.31	1.26	25.08	64.38	1114.61	0.013	975	0.25	1120.53	1.50	77.30	0.86	0.193		0.010	301.121	300.928
9	Saintsbury Line			0.11	9.52	0.40	0.04	6.27			17.44																
10	Saintsbury Line			0.34	9.86	0.40	0.14	6.41			17.81																
	Saintsbury Line	STMH.2	STMH.3	0.23	10.09	0.90	0.21	6.62			18.39	0.86	25.94	62.95	1157.55	0.013	975	0.28	1185.85	1.59	51.60	0.54	0.144		0.010	300.918	300.773
11	Saintsbury Line	STMH.3	OGS.1		10.09						18.39	0.54	26.48	62.95	1157.55	0.013	975	0.28	1185.85	1.59	4.60	0.05	0.013		0.010	300.763	300.750
1 F	Saintsbury Line	OGS.1	OUTLET		10.09						18.39	0.05	26.53	62.95	1157.55	0.013	975	0.28	1185.85	1.59	7.20	0.08	0.020		0.010	300.740	300.720
12	Alice Street			0.17	0.17	0.40	0.07	0.07			0.19																
13	Alice Street			0.24	0.41	0.40	0.10	0.16			0.46																
14	Alice Street	STMH.4	STMH.6	0.07	0.48	0.90	0.06	0.23			0.63		19.00	76.56	48.31	0.013	375	0.50	123.98	1.12	44.10	0.65	0.221			301.670	301.450
18	Alice Street			0.20	0.20	0.40	0.08	0.08			0.22																
19	Alice Street			0.21	0.41	0.40	0.08	0.16			0.46																
	Alice Street	STMH.9	STMH.8	0.10	0.51	0.90	0.09	0.25			0.71		19.00	76.56	54.06	0.013	375	0.30	96.03	0.87	33.50	0.64	0.101			301.960	301.860
20	Alice Street	STMH.8	STMH.7		0.51	0.90	0.00	0.25			0.71	0.64	19.64	75.07	53.01	0.013	375	0.30	96.03	0.87	48.20	0.92	0.145			301.860	301.715
15	Alice Street	3111110		0.27	0.78	0.40	0.11	0.36			1.01			. 2101	23.61	2.010					. 3120	3.04					
16	Alice Street			0.40	1.18	0.40	0.16	0.52			1.45																
17	Alice Street	STMH.7	STMH.6	0.14	1.32	0.90	0.13	0.65			1.80	0.92	20.57	73.03	131.55	0.013	450	0.27	148.15	0.93	70.80	1.27	0.191		0.070	301.645	301.454
17	Alice Street			0.14		0.80	0.13																				
		STMH.6	STMH.5		1.80			0.65			1.80	0.65	19.65	75.04	135.19	0.013	450	0.30	156.16	0.98	14.90	0.25	0.045		0.050	301.404	301.359

Conditions of Use

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				DESIGN	REVIEWED BY			
				JCW	JDJ			
				DRAWN	CHECKED BY			
				JCW	JDJ			
				DATE				
3	ISSUED FOR CONSTRUCTION	2022-05-02	NCG	FEBRUARY 2022				
2	ISSUED FOR TENDER	2022-02-28	AMB	SCALE				
1	ISSUED FOR FINAL CLIENT REVIEW	2022-02-04	JCW	OOALL				
No.	ISSUED FOR	DATE	BY					


STORM SEWER SYSTEM
STORM SEWER DESIGN SHEET


SAINTSBURY LINE AND ALICE STREET

TOWNSHIP OF LUCAN-BIDDULPH

ST2

SHEET NO.

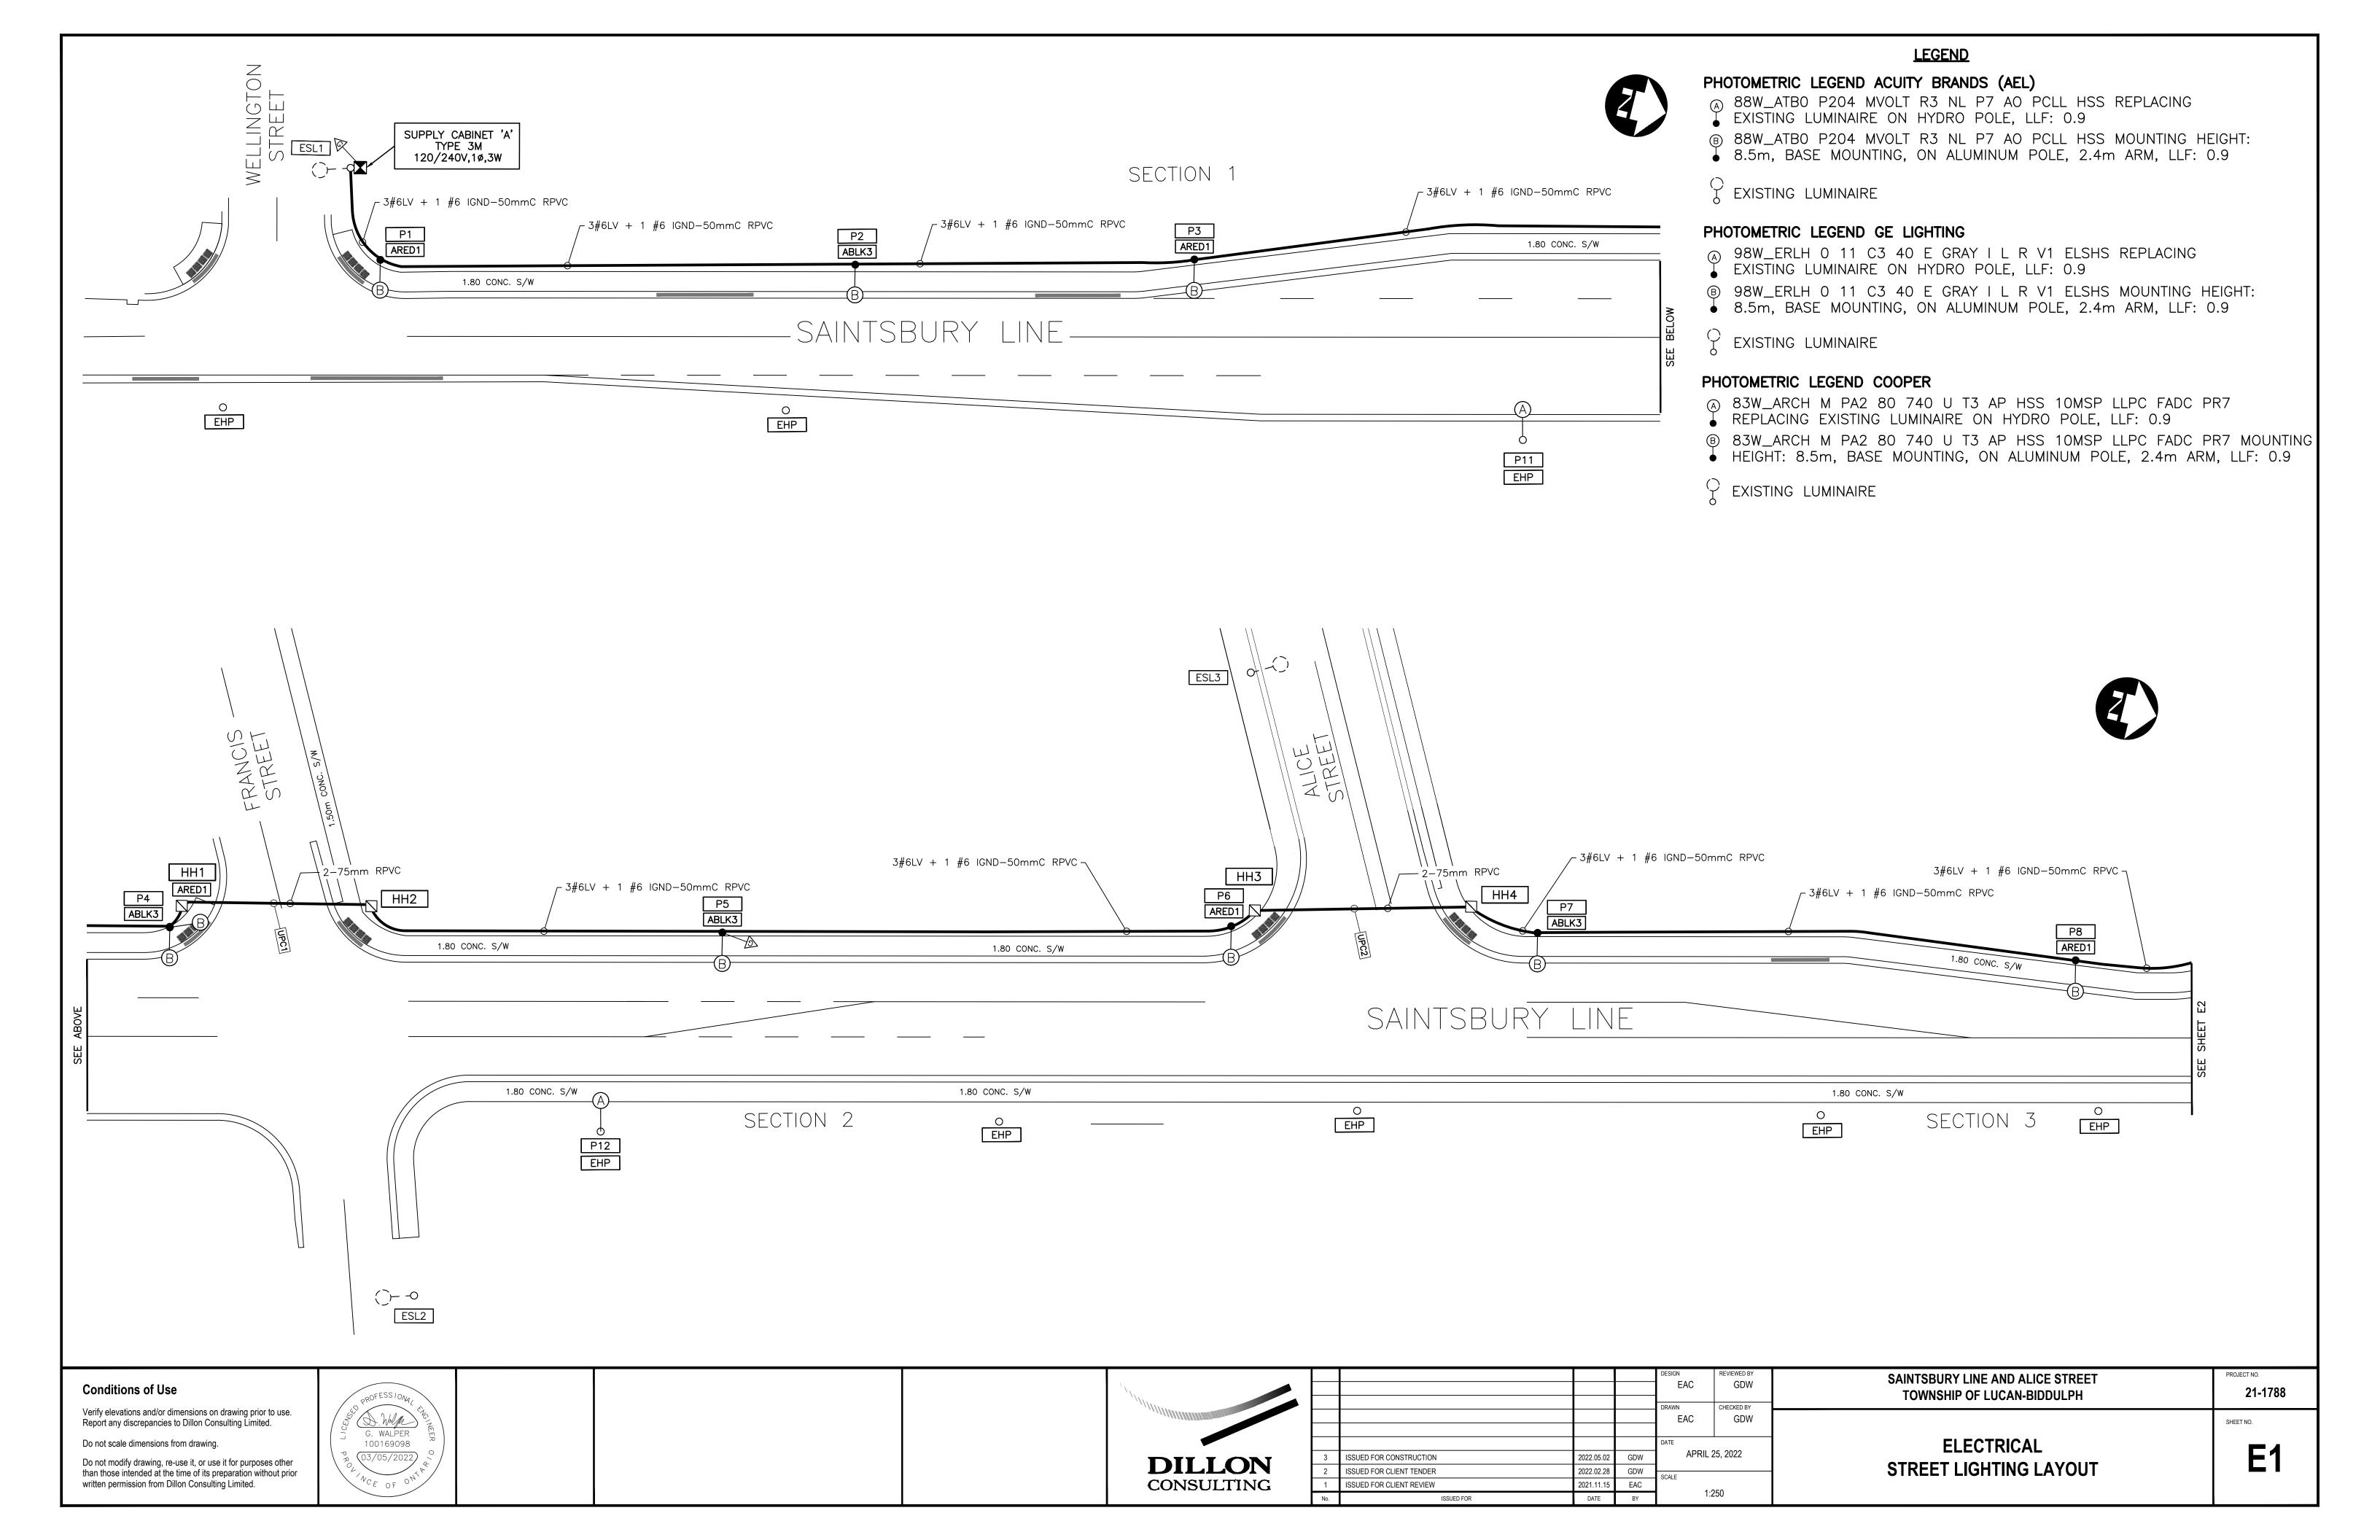

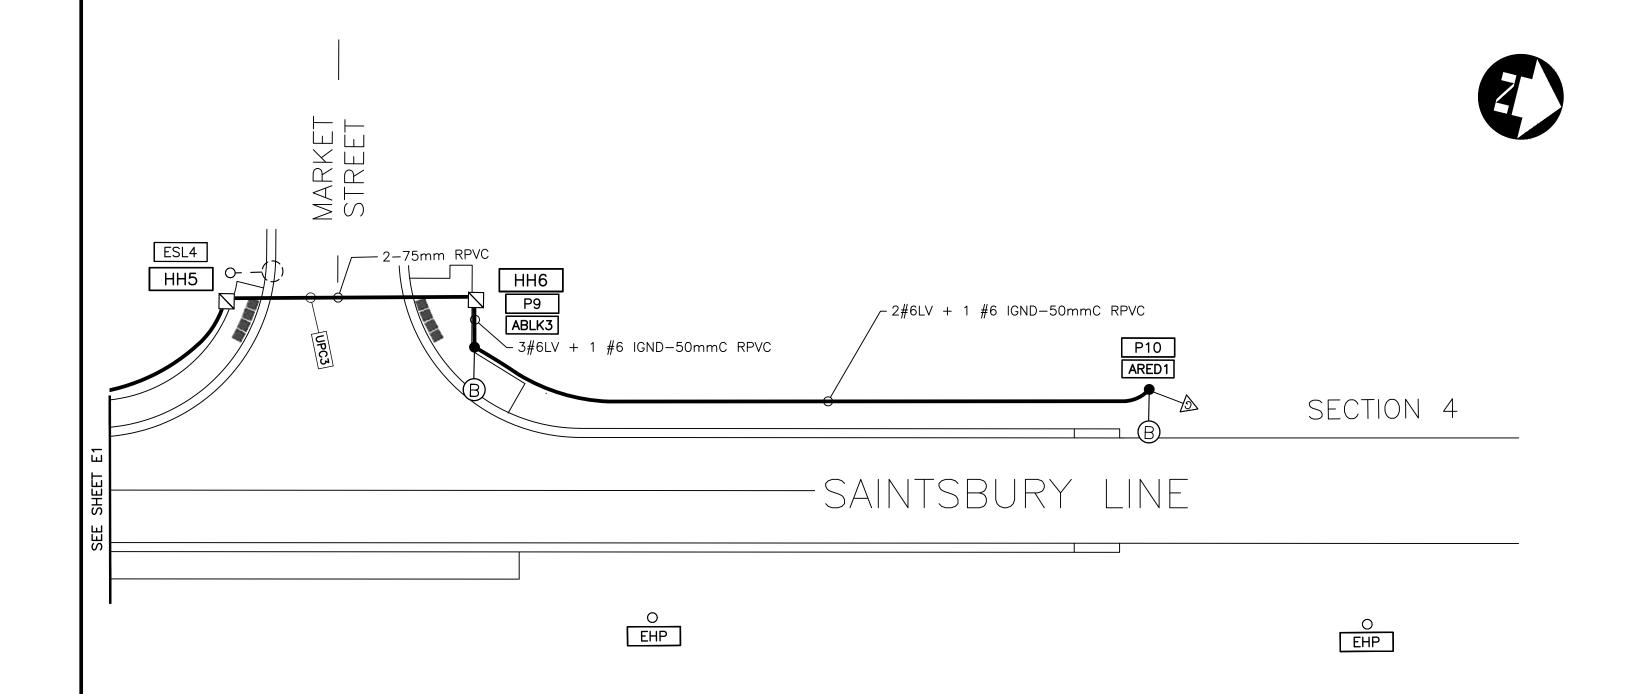

# GENERAL NOTES:

- A. THE TOWNSHIP OF LUCAN AND DILLON CONSULTING LIMITED DO NOT GUARANTEE THE ACCURACY OF THE UTILITIES SHOWN ON THE DRAWINGS. OTHER UTILITIES MAY BE PRESENT OR THE UTILITIES SHOWN MAY DIFFER IN SIZE OR LOCATION FROM THOSE SHOWN THE CONTRACTOR SHALL NOTE THAT SERVICES FROM THE MAIN LINES ARE NOT SHOWN. THE CONTRACTOR ASSUMES FULL RESPONSIBILITY TO CONTACT THE VARIOUS UTILITY COMPANIES AND TO REPAIR ANY DAMAGE IT MAY CAUSE TO THESE UTILITIES OR TO OTHER THIRD PARTIES. THE CONTRACTOR AGREES TO INDEMNIFY THE OWNER AND DILLON CONSULTING LIMITED AGAINST ANY CLAIMS WHICH MAY ARISE FROM THE CONTRACTOR'S ACTIONS.
- B. ELECTRICAL INSTALLATION SHALL BE IN ACCORDANCE WITH THE CANADIAN ELECTRICAL CODE (LATEST EDITION) AND THE REQUIREMENTS OF THE TOWNSHIP OF LUCAN.
- C. ANY WORKER PERFORMING WORK ON OR NEAR ELECTRICAL TRANSMISSION OR ELECTRICAL DISTRIBUTION SYSTEMS SHALL BE CERTIFIED UNDER THE UTILITY WORK PROTECTION CODE LATEST EDITION. WORK SHALL BE PERFORMED IN ACCORDANCE TO THE ELECTRICAL SAFETY RULES AS PUBLISHED BY THE ELECTRICAL AND UTILITIES SAFETY ASSOCIATION OF ONTARIO AND THE ONTARIO OCCUPATIONAL HEALTH AND SAFETY ACT FOR CONSTRUCTION PROJECTS.
- D. ALL ELECTRICAL WORK PERFORMED MUST MEET THE REQUIREMENTS OF THE ONTARIO ELECTRICAL SAFETY CODE, WHICH INCLUDES INSPECTIONS BY THE ELECTRICAL SAFETY AUTHORITY.
- E. CHECK ALL FIELD CONDITIONS AND ALL DIMENSIONS, REPORT ANY INCONSISTENCIES TO THE ENGINEER BEFORE PROCEEDING WITH THE WORK. DO NOT SCALE DRAWINGS. CONTRACTOR SHALL HOLD SITE MEETING WITH CONSULTING ENGINEER AFTER UTILITY LOCATES AND PRIOR TO VACUUMING FOR POLE BASES (IF NECESSARY).
- F. ALL FINAL CONNECTIONS OF LUMINARIES TO POLES ARE NOT DETAILED ON THIS DRAWING. ALL CONNECTIONS INCLUDING HOW THE LUMINARIES ARE INSTALLED IS TO BE FINALIZED AND COMPLETED ON SITE AND APPROVED BY HYDRO ONE
- G. CONTRACTOR IS REQUIRED TO COORDINATE WITH HYDRO ONE FOR THE LUMINAIRE CONNECTIONS AND POWER SUPPLY

# PHOTOMETRIC LEGEND ACUITY BRANDS (AEL)

(A) 88W\_ATBO P204 MVOLT R3 NL P7 AO PCLL HSS REPLACING

**LEGEND** 

- EXISTING LUMINAIRE ON HYDRO POLE, LLF: 0.9
- ® 88W\_ATBO P204 MVOLT R3 NL P7 AO PCLL HSS MOUNTING HEIGHT:
- ♣ 8.5m, BASE MOUNTING, ON ALUMINUM POLE, 2.4m ARM, LLF: 0.9
- T EXISTING LUMINAIRE

# PHOTOMETRIC LEGEND GE LIGHTING

- (A) 98W\_ERLH 0 11 C3 40 E GRAY I L R V1 ELSHS REPLACING
- $\stackrel{\smile}{\downarrow}$  EXISTING LUMINAIRE ON HYDRO POLE, LLF: 0.9
- 8.5m, BASE MOUNTING, ON ALUMINUM POLE, 2.4m ARM, LLF: 0.9
- EXISTING LUMINAIRE

# PHOTOMETRIC LEGEND COOPER

- A 83W\_ARCH M PA2 80 740 U T3 AP HSS 10MSP LLPC FADC PR7
- FEPLACING EXISTING LUMINAIRE ON HYDRO POLE, LLF: 0.9
- ® 83W\_ARCH M PA2 80 740 U T3 AP HSS 10MSP LLPC FADC PR7 MOUNTING
- → HEIGHT: 8.5m, BASE MOUNTING, ON ALUMINUM POLE, 2.4m ARM, LLF: 0.9
- EXISTING LUMINAIRE

# ONTARIO PROVINCIAL STANDARDS SPECIFICATIONS (OPSS)

- 106 GENERAL SPECIFICATION FOR ELECTRICAL WORK
- 602 CONSTRUCTION SPECIFICATION FOR ELECTRICAL CHAMBERS
- 603 CONSTRUCTION SPECIFICATION FOR INSTALLATION OF DUCTS
- 604 CONSTRUCTION SPECIFICATION FOR INSTALLATION OF CABLE
- 609 CONSTRUCTION SPECIFICATION FOR GROUNDING
- 614 CONSTRUCTION SPECIFICATION FOR POWER SUPPLY EQUIPMENT


- 615 CONSTRUCTION SPECIFICATION FOR INSTALLATION OF POLES
- 616 CONSTRUCTION SPECIFICATION FOR FOOTINGS AND PADS
- 617 CONSTRUCTION SPECIFICATION FOR ROADWAY LUMINAIRES

# **Conditions of Use**

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				DESIGN	REVIEWED BY	
				EAC	GDW	
				DRAWN	CHECKED BY	
				EAC	GDW	
				DATE		
3	ISSUED FOR CONSTRUCTION	2022.05.02	GDW	APRIL 2	25, 2022	
2	ISSUED FOR CLIENT TENDER	2022.02.28	GDW	SCALE		
1	ISSUED FOR CLIENT REVIEW	2021.11.15	EAC		250	
Nο	ISSUED FOR	DATE	BY	1:2	250	


**ELECTRICAL** STREET LIGHTING LAYOUT

SAINTSBURY LINE AND ALICE STREET

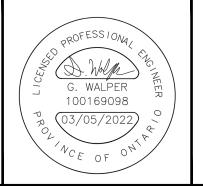TOWNSHIP OF LUCAN-BIDDULPH

SHEET NO.

21-1788

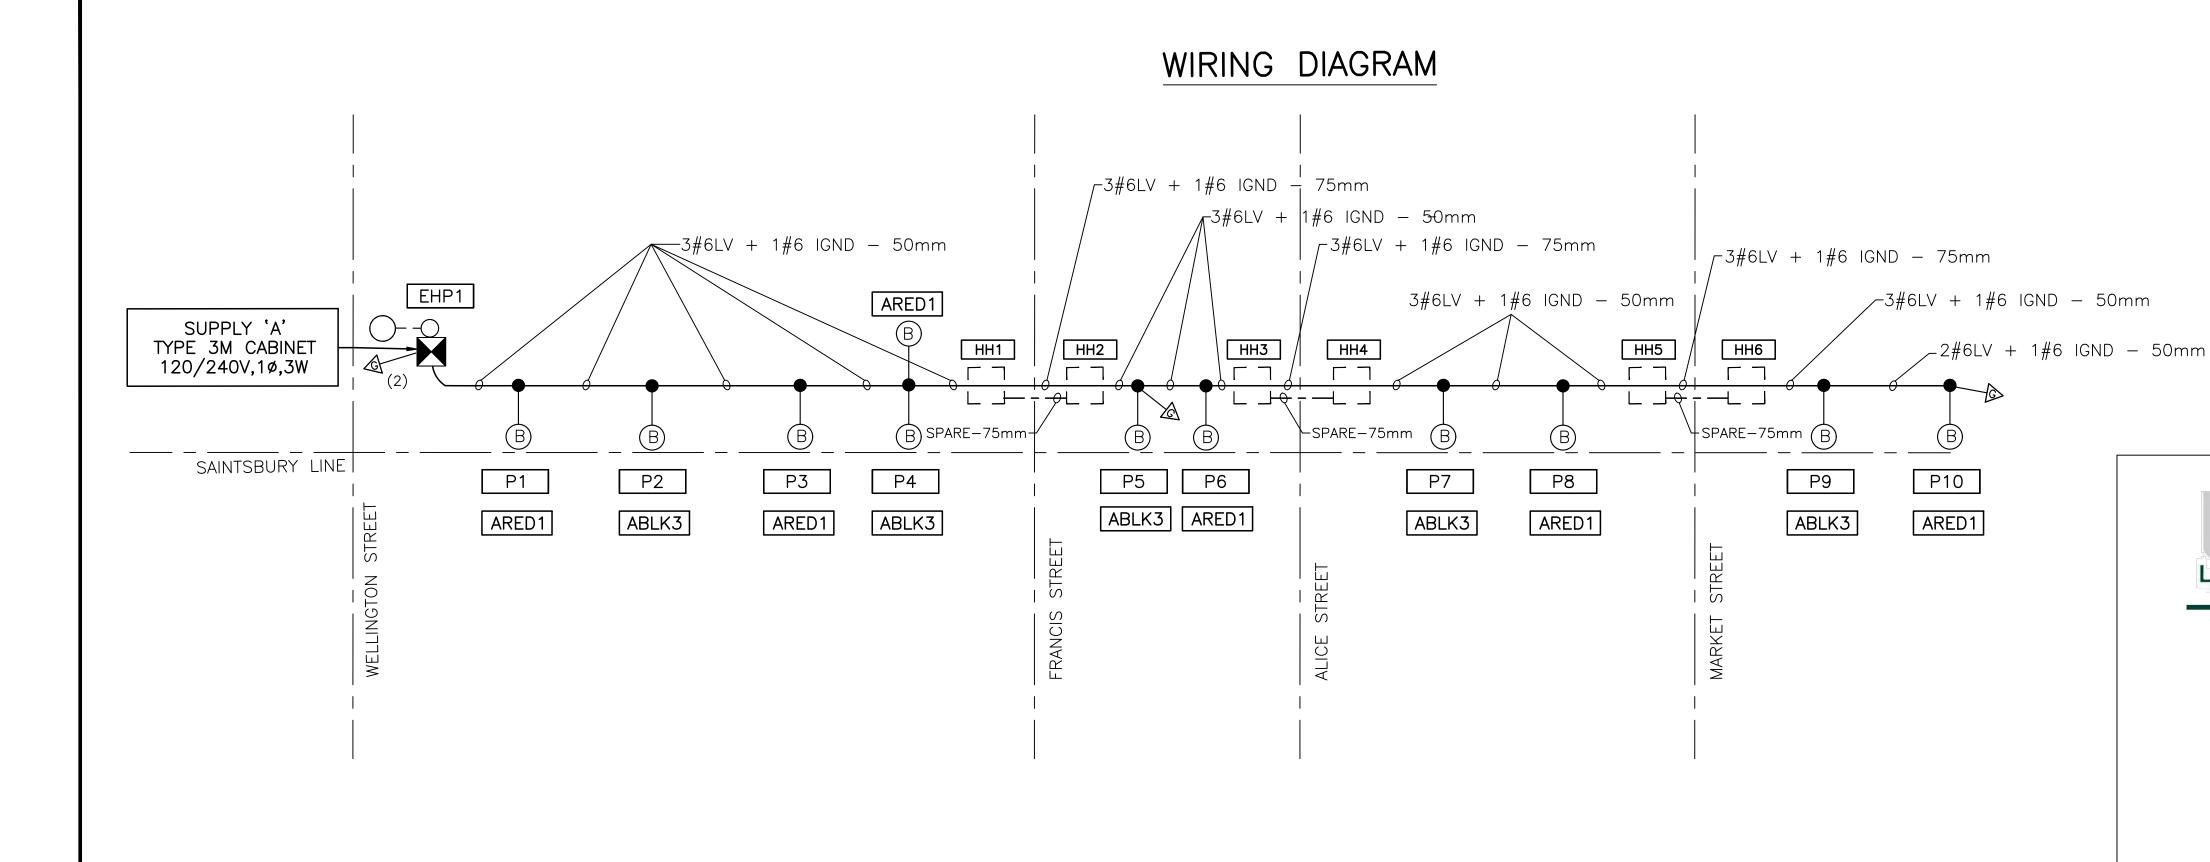

# SUPPLEMENTARY LEGEND

A NEW LUMINAIRE AND TYPE WITH EXISTING BRACKET

(B)—— NEW POLE AND LUMINAIRE

O EXISTING HYDRO POLE

BASE MOUNTED POLE


POWER SUPPLY ASSEMBLY

PROPOSED GROUND ROD (2 - DENOTES TWO GROUND RODS AT THIS LOCATION)

I O A			LIDDLY 'A' CAINTODLIDY LINE	
LUA	ADING I	IABLE 2	UPPLY 'A' SAINTSBURY LINE	
SUPPLY LOCATION	AMPS	CIRCUIT No.	LOAD DESCRIPTION	TOTAL LOAD
	20/1P	ARED1	6 x 98 LTG	588
	20/1P	ABLK3	5 x 98 LTG	490
<b>&gt;</b>				
UR				
SAINTSBURY LINE				
ΗI				
SAI				
			TOTAL LOAD	= 1078 W



Supplemental Standards for Traffic Signal and Street Lighting (STS)

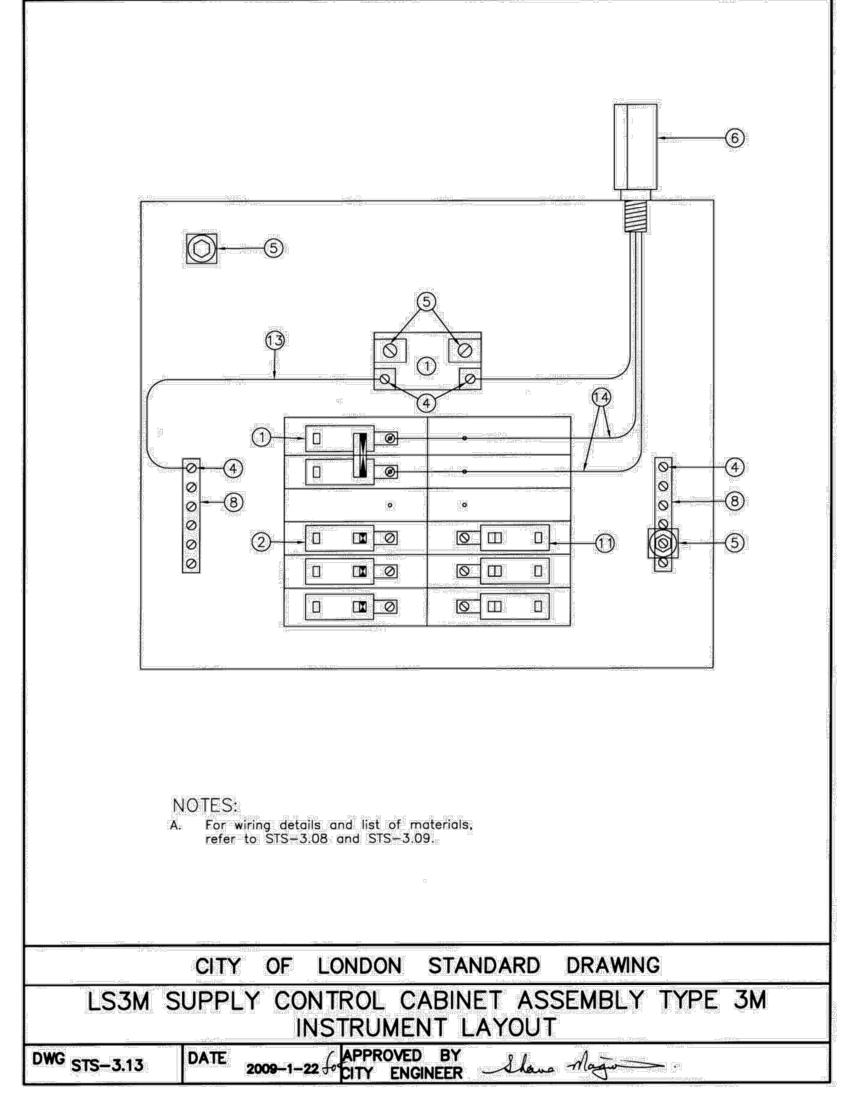

Standard Contract Documents for Municipal Construction Projects 2020 Edition

293

SHEET NO.

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DILLON	
CONSULTING	

				DESIGN	REVIEWED BY	
				EAC	GDW	
				DRAWN	CHECKED BY	
				EAC	GDW	
				DATE		
3	ISSUED FOR CONSTRUCTION	2022.05.02	GDW	APRIL 25, 2022  SCALE		
2	ISSUED FOR CLIENT TENDER	2022.02.28	GDW			
1	ISSUED FOR CLIENT REVIEW	2021.11.15	EAC			
No.	ISSUED FOR	DATE	BY			

ELECTRICAL
<b>WIRING DIAGRAM AND DETAILS</b>

SAINTSBURY LINE AND ALICE STREET

TOWNSHIP OF LUCAN-BIDDULPH

**E**3

21-1788






# **Autobahn** Series ATB0 **Roadway Lighting**

### PRODUCT OVERVIEW



# **Applications:**

Off ramps Residential streets Parking lots

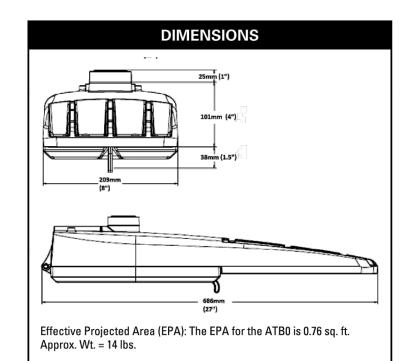

# **STANDARDS**

DesignLights Consortium® (DLC) qualified product. Not all versions of this product may be DLC qualified. Please check the DLC Qualified Products List at <u>www.designlights.org/QPL</u> to confirm which versions are qualified.

Color temperatures of  $\leq$  3000K must be specified for International Dark-Sky Association certification.

Rated for -40°C to 40°C ambient CSA Certified to U.S. and Canadian standards Complies with ANSI: C136.2, C136.10, C136.14, C136.31, C136.15, C136.37

# Features:

### **OPTICAL**

The Autobahn's new molded silicone optics provide exceptional performance. Silicone optics are superior to other polymeric materials in the areas of; optical efficiency, thermal performance, and reduction in dirt accumulation, all of which can lead to long term lumen degradation and a shift in optical distribution. Also, because silicone allows for the molding of fine details as well as thick sections, it produces the most crisp, clean and well-defined lighting distributions available. Silicone optics paired with modern LED's allow the Autobahn to take full advantage of both technologies.

Same Light: Performance is comparable to 100 - 400W HPS roadway luminaires.

White Light: Correlated color temperature - 4000K, or optional 2700K, 3000K or 5000K, all 70 CRI

Unique IP66 rated LED light engines provided 0% uplight and restrict backlight to within sidewalk depth, providing optimal application coverage and optimal pole spacing. Available in Type II, III, IV, and V roadway distributions.

### **ELECTRICAL**

Expected Life: LED light engines are rated >100,000 hours at 25°C, L70. Electronic driver has an expected life of 100,000 hours at a 25°C ambient.

Lower Energy: Saves an expected of 40-60% over comparable HID luminaires.

Robust Surge Protection: Two different surge protection options provide a minimum of ANSI C136.2 10kV/5kA protection. 20kV/10kA protection is also available.

Luminaire ships with a 0-10v dimmable driver. Luminaire is continuous and step dimming capable via AO option or controls installed on P7 photocontrol receptacle option.

# **MECHANICAL**

Includes standard AEL lineman-friendly features such as tool-less entry, 3 station terminal block and quick disconnects. Bubble level located inside the electrical compartment for easily leveling

Rugged die-cast aluminum housing and door are polyester powder-coated for durability and corrosion resistance. Rigorous five-stage pre-treating and painting process yields a finish that achieves a scribe creepage rating of 7 (per ASTM D1654) after over 5000 hours exposure to salt fog chamber (operated per ASTM B117).

Mast arm mount is adjustable for arms from 1-1/4" to 2" (1-5/8" to 2-3/8" 0.D.) diameter. Provides a 3G vibration rating per ANSI C136.31

Wildlife shield is cast into the housing (not a separate piece).

# **CONTROLS**

NEMA 3 pin photocontrol receptacle is standard, with the Acuity designed ANSI standard 7 pin

Premium solid state locking style photocontrol - PCSS (10 year rated life) Extreme long life solid state locking style photocontrol - PCLL (20 year rated life).

Optional onboard Adjustable Output module allows the light output and input wattage to be modified to meet site specific requirements, and also can allow a single fixture to be flexibly applied in many different applications.

Note: Specifications subject to change without notice. Actual performance may differ as a result of end-user environment and application.

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Interactive Menu

**Quick Facts** 

tool-less entry

arm mounting

40°C operating range

operation; IP66 rated

**Dimensional Details** 

Adjustable Slipfitter Offset Arm

• Ordering Information page 2

• Product Specifications page 2

• Energy and Performance Data page 3

• Die-cast aluminum construction; Single latch

Replaces up to 400W equivalent HID; -40°C to

• 120-277V 50/60Hz, 347V 60Hz or 480V 60Hz

Pole-mounted; Optional arm and offset adjustable

15" Straight Arm

# **Streetworks**

# **Archeon Medium**

Roadway Luminaire

# **Product Features**



# **Product Certifications**














 WaveLinx Enlighted

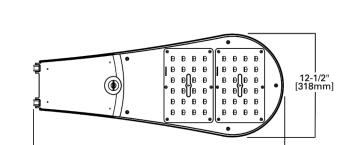

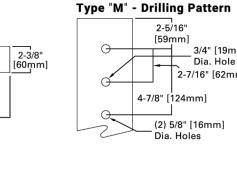

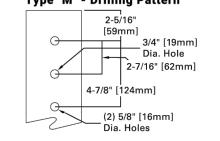





The **Evolve**® LED Roadway ERLH Luminaire is optimized utilizing advanced LED reflective optical system for local, collector and major roadways. The modern design incorporates the heat sink directly into the unit for heat transfer to prolong LED life.

Projected Lxx per IES TM-21-11 at 25°C

Note: Projected Lxx based on LM80 (≥ 10,000 hour testing). Accepted Industry

tolerances apply to initial luminous flux and lumen maintenance measurements.

**RATINGS** 

**Temperature:** ERLH Lumen outputs 14-16 (-40°C to 45°C)

**LM-79:** Testing in accordance with IES Standards

**CONTROLS** 

Optional - DALI (Option U)

**Sensors:** Photo Electric Sensors (PE) available

**WARRANTY** 

LightGrid Compatible

**Vibration:** 3G per ANSI C136.31-2018

Standard - 0-10V

**Operating** ERLH Lumen outputs 10-11, 13 (-40°C to 50°C)

LXX(10K) @ Hours

25.000 HR 50,000 HR 60,000 HR



A3, B3, C3,

D3, E3

A3, B3, C3,

D3, E3

A3, B3, C3,

D3, E3

Aluminum die cast enclosure casting integral heat sink for maximum heat transfer **Lens:** Impact resistant tempered glass Corrosion resistant powder paint, ≥ 2.0 mil thickness **Paint:** (RAL & custom colors available)

Standard = Black, Dark Bronze, Gray, White Optional = Coastal Finish 15.15 lbs (6.9 kgs) w/ 2 Bolt Slipfitter 15.85 lbs (7.2 kgs) w/ 4 Bolt Slipfitter

### **OPTICAL SYSTEM**

**Lumens:** 10,000-16,000 **Distribution:** Type II Narrow, Type II Wide, Type III, Type IV and Type II **Enhanced Back Light Efficacy:** 110-143 LPW **CCT:** 2700K, 3000K, 4000K **CRI:** ≥70 **ELECTRICAL Input Voltage:** 120-277V or 347-480V

**Input Frequency:** 50/60Hz **Power Factor:** ≥ 90% at rated watts **Total Harmonic** ≤ 20% at rated watts

**GE current** 

a Daintree company

# **SURGE PROTECTION\***

**Standard Optional** Secondary 10kV/5kA (R Option) or 10kV/5kA Secondary 20kV/10kA (T Option) \*Per ANSI C136.2-2018

# 5 Year (Standard)









10 Year (Optional)

Not all product variations listed on this page are DLC qualified. Visit www.designlights.org/search to confirm qualifications.

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**DILLON** CONSULTING

			DESIGN	REVIEWED BY	
			EAC	GDW	
			DRAWN	CHECKED BY	
			EAC	GDW	
			2,10	05	
			APRIL 25, 2022		
ISSUED FOR CONSTRUCTION	2022.05.02	GDW			
ISSUED FOR CLIENT TENDER	2022.02.28	GDW	SCALE		
ISSUED FOR CLIENT REVIEW	2021.11.15	EAC	SOALL		
ISSUED FOR	DATE	BY			

PS506050EN page 1

May 12, 2021 10:34 AM

**ELECTRICAL LUMINAIRES SPEC SHEET** 

SAINTSBURY LINE AND ALICE STREET

TOWNSHIP OF LUCAN-BIDDULPH

SHEET NO.

21-1788